



AMORY AT RIPLEY

STAGE 01

RIPLLEY ESTATE DEVELOPMENT PTY LTD

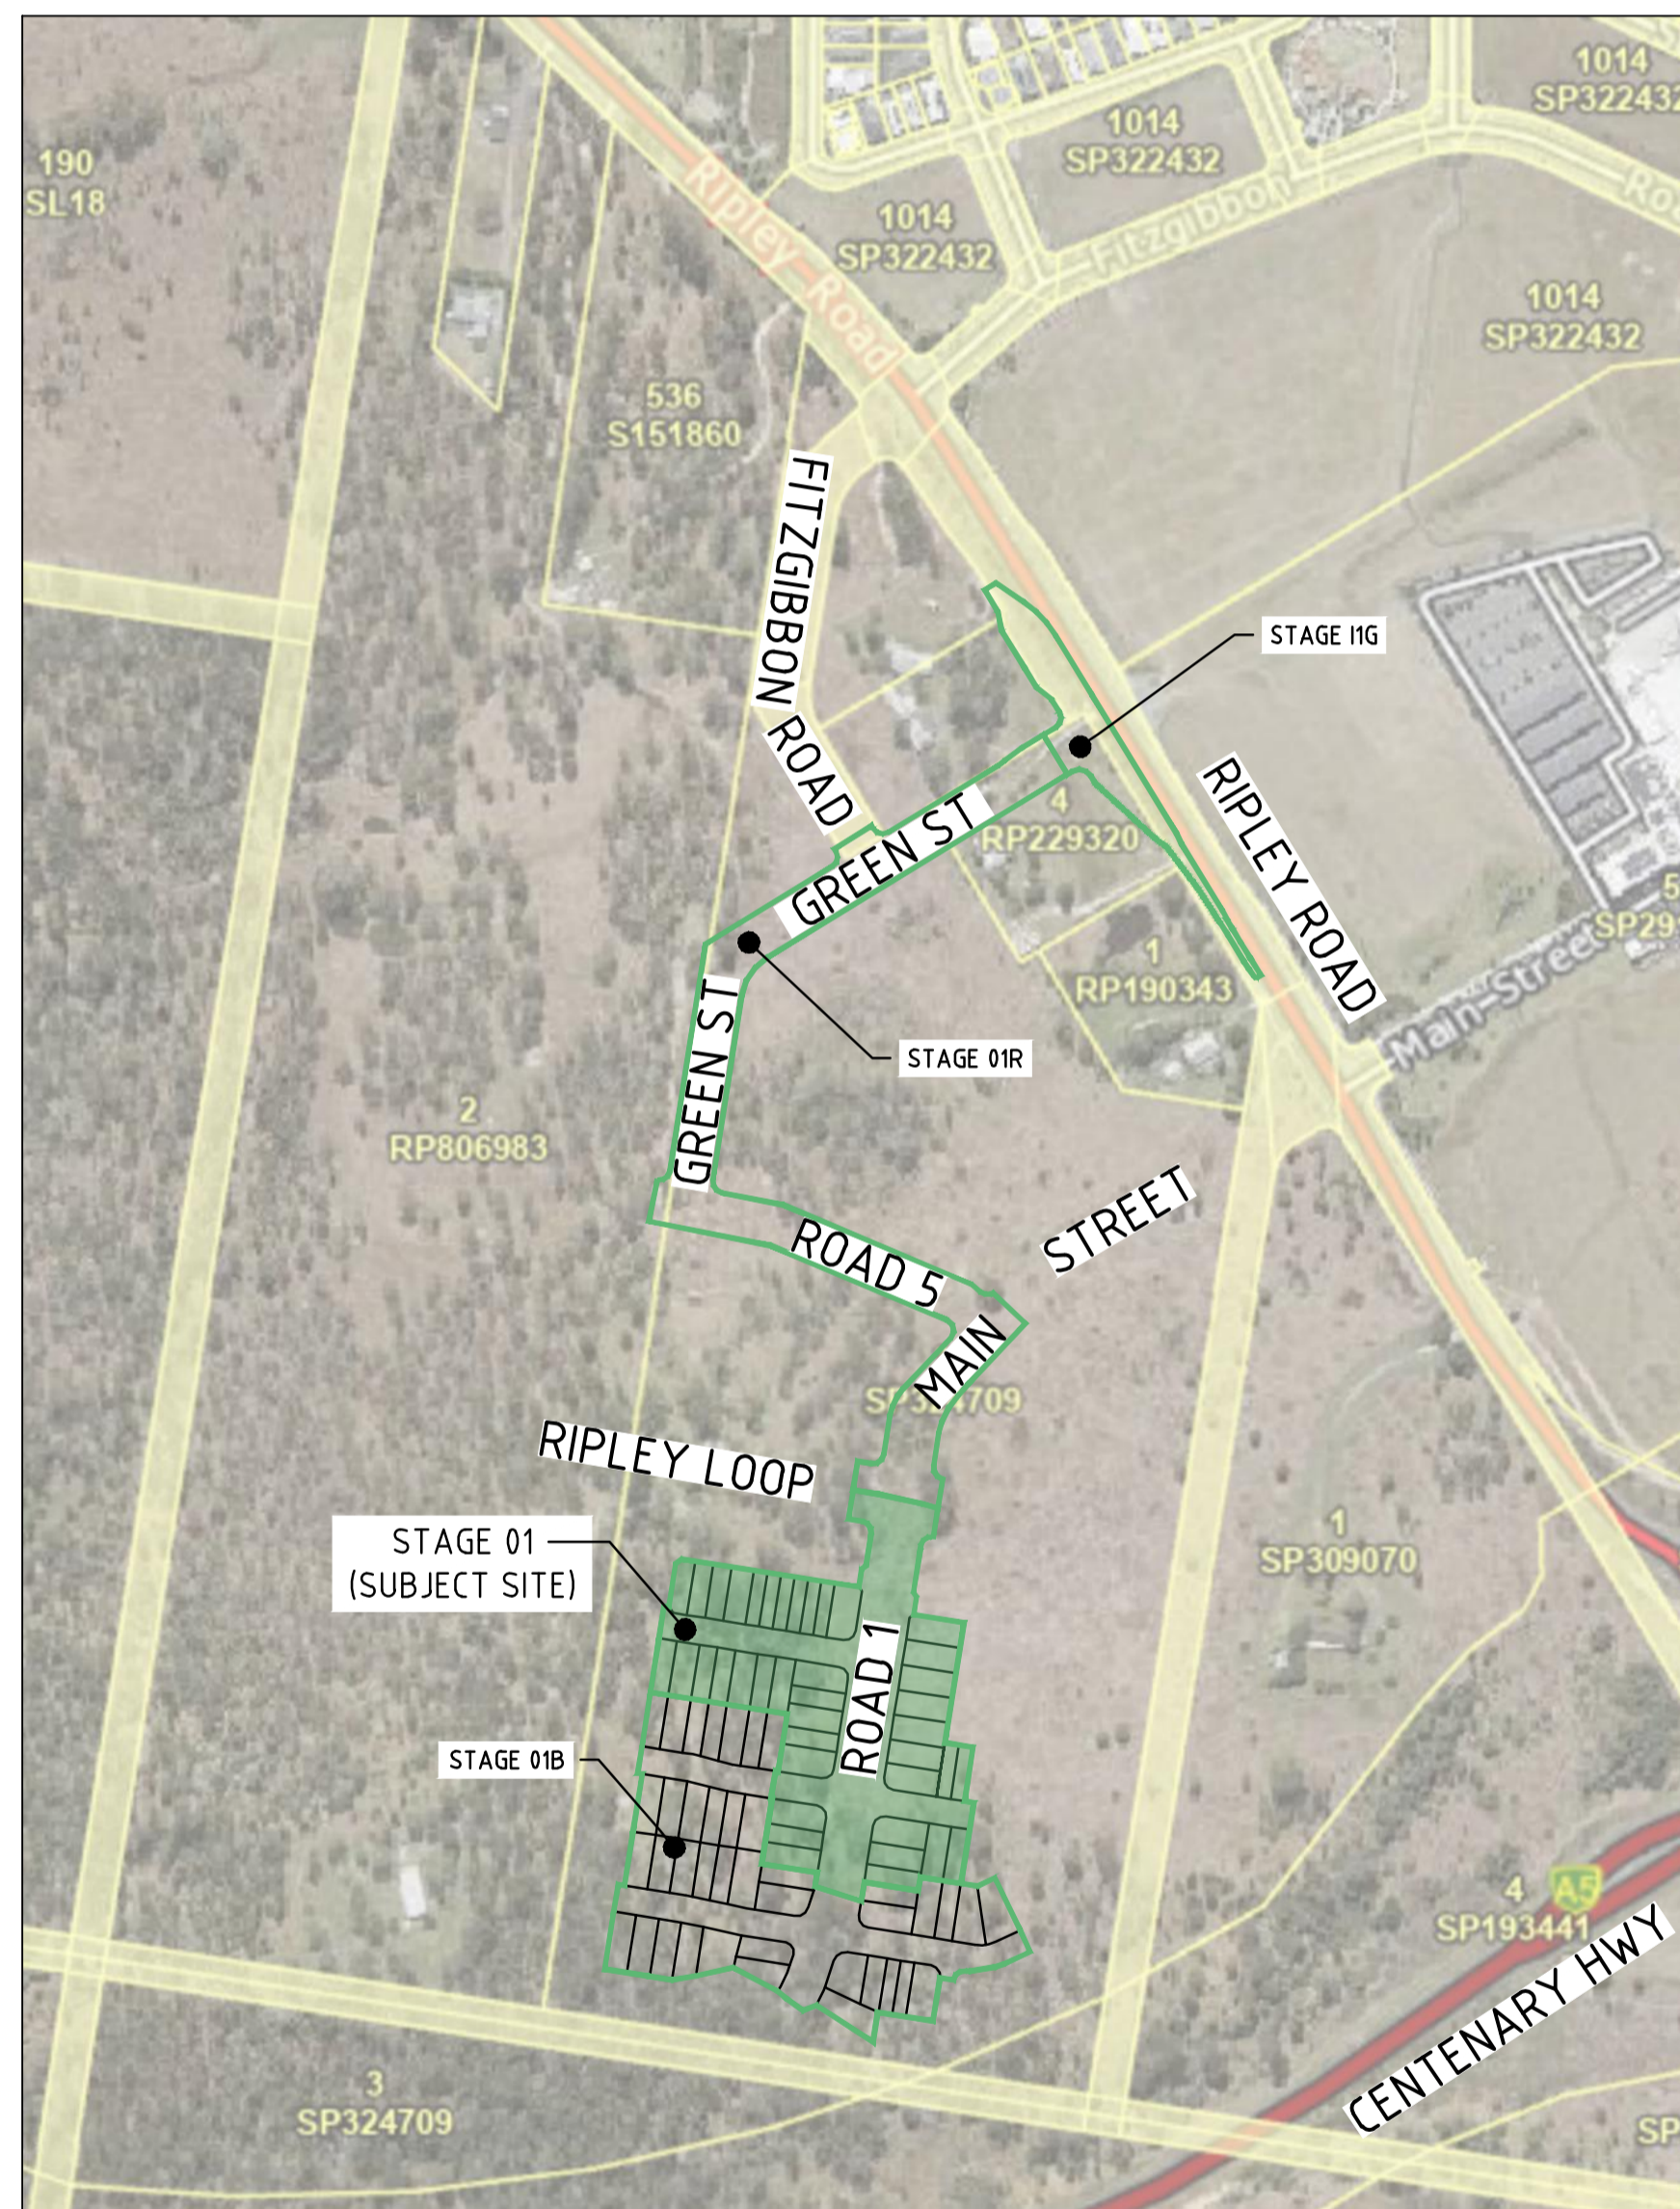

LOCALITY PLAN
N.T.S.

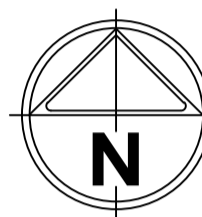

DRAWING SCHEDULE		
DRAWING	DESCRIPTION	REVISION
GENERAL		
320678-01AC0100	DRAWING SCHEDULE & LOCALITY PLAN	A
320678-01AC0101	GENERAL NOTES & LEGEND	A
320678-01AC0102	OVERALL KEY PLAN	A
320678-01AC0103	CONTROL LINE LAYOUT PLAN & TYPICAL SECTIONS	A
EARTHWORKS		
320678-01AC0200	EARTHWORKS LAYOUT PLAN - SHEET 1 OF 2	A
320678-01AC0201	EARTHWORKS LAYOUT PLAN - SHEET 2 OF 2	A
320678-01AC0202	EARTHWORKS SITE SECTIONS	A
ROADWORKS		
320678-01AC0300	ROADWORKS STANDARD NOTES & DETAILS	A
320678-01AC0301	ROADWORKS LAYOUT PLAN - SHEET 1 OF 2	A
320678-01AC0302	ROADWORKS LAYOUT PLAN - SHEET 2 OF 2	A
320678-01AC0303	ROAD 1 LONGITUDINAL SECTIONS - SHEET 1 OF 2	A
320678-01AC0304	ROAD 1 LONGITUDINAL SECTIONS - SHEET 2 OF 2	A
320678-01AC0305	ROAD 1 CROSS SECTIONS - SHEET 1 OF 2	A
320678-01AC0306	ROAD 2 LONGITUDINAL SECTIONS	A
320678-01AC0307	ROAD 2 CROSS SECTIONS	A
320678-01AC0308	ROAD 3 & ROAD 4 LONGITUDINAL SECTIONS	A
320678-01AC0309	ROAD 3 & ROAD 4 CROSS SECTIONS	A
320678-01AC0310	RIPLLEY LOOP/ROAD 1 INTERSECTION DETAIL	A
320678-01AC0311	ROAD1/ROAD 2 INTERSECTION DETAIL	A
320678-01AC0312	ROAD 3/ROAD 4 INTERSECTION DETAILS - SHEET 1 OF 2	A
320678-01AC0313	ROAD 3/ROAD 4 INTERSECTION DETAILS - SHEET 2 OF 2	A
320678-01AC0314	TRAFFIC ISLAND SETOUT DETAILS	A
SIGNAGE & LINEMARKING		
320678-01AC0400	SIGNAGE & LINEMARKING DETAILED LAYOUT PLAN - SHEET 1 OF 2	A
320678-01AC0401	SIGNAGE & LINEMARKING DETAILED LAYOUT PLAN - SHEET 2 OF 2	A
STORMWATER DRAINAGE		
320678-01AC0500	STORMWATER DRAINAGE STANDARD NOTES & DETAILS	A
320678-01AC0501	STORMWATER DRAINAGE CATCHMENT PLAN	A
320678-01AC0502	STORMWATER DRAINAGE LONGITUDINAL SECTIONS - SHEET 1 OF 4	A
320678-01AC0503	STORMWATER DRAINAGE LONGITUDINAL SECTIONS - SHEET 2 OF 4	A
320678-01AC0504	STORMWATER DRAINAGE LONGITUDINAL SECTIONS - SHEET 3 OF 4	A
320678-01AC0505	STORMWATER DRAINAGE LONGITUDINAL SECTIONS - SHEET 4 OF 4	A
320678-01AC0506	STORMWATER DRAINAGE CALCULATION TABLE - SHEET 1 OF 2	A
320678-01AC0507	STORMWATER DRAINAGE CALCULATION TABLE - SHEET 2 OF 2	A
SAFETY IN DESIGN REPORT		
320678-01AC0900	SAFETY IN DESIGN REPORT	A



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file name: 320678-01AC0100.dwg; layout: ripley; plot by: Michael Bremer; file location: C:\Users\michael.bremer\OneDrive\Documents\320678-01AC0100.dwg; plot date: 23/02/2024, 3:57 PM; Sheet 2 of 11; Sheets

Rev	Amendments	Approved	Date
B	ISSUE FOR TENDER	K.H.	21-02-24
A	ISSUE FOR APPROVAL	K.H.	01-12-23

Scale
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DECEMBER 23

AMORY AT RIPLEY
STAGE 01
 COVER SHEET, LOCALITY PLAN AND DRAWING SCHEDULE
 IPSWICH CITY COUNCIL
 RIPLEY ROAD DEVELOPMENT PTY LTD
PRELIMINARY Dwg No **320678-01C0100** Rev **B**

NOTES:

GENERAL

- ALL LEVELS ARE TO AUSTRALIAN HEIGHT DATUM
- ALL EXISTING SURFACE LEVELS SHOWN ON THE ENGINEERING DRAWINGS HAVE BEEN INTERPOLATED FROM A DIGITAL TERRAIN MODEL. THESE LEVELS HAVE BEEN USED AS THE BASIS FOR ALL ENGINEERING DESIGN AND DETERMINATION OF QUANTITIES AND ARE ACCURATE TO WITHIN ±0.05m.
- ALL WORKS TO BE CARRIED OUT IN ACCORDANCE WITH AS2124-1992 GENERAL CONDITIONS OF CONTRACT, SPECIFICATIONS, APPROVED AUTHORITY SPECIFICATIONS AND STANDARD DRAWINGS, AUSTRALIAN STANDARDS AND TO THE SATISFACTION OF THE SUPERINTENDENT AND THE COUNCIL ENGINEER OR THEIR REPRESENTATIVE.
- ROAD CHAINAGES REFER TO ROAD CENTRELINES. CHAINAGES FOR INTERSECTIONS AND CUL-DE-SACS REFER TO THE LIP OF KERB.
- CONTRACTOR TO VERIFY LOCATION OF ALL EXISTING SURFACES AND CONNECTION POINTS INCLUDING CONNECTION LEVELS AND ADVISE THE SUPERINTENDENT OF ANY DISCREPANCIES PRIOR TO COMMENCEMENT ON SITE.
- ALL EROSION AND SEDIMENT CONTROL MEASURES ARE TO BE IMPLEMENTED IN ACCORDANCE WITH THE EROSION AND SEDIMENT CONTROL PLANS, BEST PRACTICE AND IN ACCORDANCE WITH INTERNATIONAL EROSION CONTROL ASSOCIATION PRACTICES AND GUIDELINES.
- PROJECT SURVEYOR SHALL PEG COMMON BOUNDARY WITH ADJOINING PROPERTIES.
- CONTRACTOR SHALL ASSESS LOCATION AND LEVEL OF ANY EXISTING FENCING AND RETAINING WALLS RELATIVE TO PROPOSED RETAINING WALL CONSTRUCTION.
- CONTRACTOR MUST PROVIDE TEMPORARY PROPPING AS NECESSARY TO ENSURE THAT PROPOSED CONSTRUCTION WORKS DO NOT CAUSE ANY DAMAGE OR DRAINAGE ISSUES TO EXISTING NEIGHBORING PROPERTIES.
- CONTRACTOR TO PROVIDE DILAPIDATION REPORT OF ALL ASSETS IN THE VICINITY OF WORKS

EARTHWORKS

- ALL LEVELS ARE TO AUSTRALIAN HEIGHT DATUM
- ALL EXISTING SURFACE LEVELS SHOWN ON THE ENGINEERING DRAWINGS HAVE BEEN INTERPOLATED FROM A DIGITAL TERRAIN MODEL. THESE LEVELS HAVE BEEN USED AS THE BASIS FOR ALL ENGINEERING DESIGN AND DETERMINATION OF QUANTITIES.
- THE CONTRACTOR SHALL ADVISE THE COUNCIL INSPECTOR OF THE PROPOSED SOURCE OF IMPORTED FILL TO BE BROUGHT ONTO THE DEVELOPMENT SITE AND PROVIDE CERTIFICATION (IF REQUESTED BY COUNCIL) FROM THE SUPPLIER / GEOTECHNICAL CONSULTANT.
- THE CONTRACTOR SHALL ALSO ADVISE THE COUNCIL INSPECTOR OF THE PROPOSED HAUL ROUTE TO BE TAKEN BY ANY TRUCKS DELIVERING FILL TO THE PROPOSED DEVELOPMENT SITE.
- IT IS THE PRINCIPAL CONTRACTOR'S RESPONSIBILITY TO ENSURE THAT NO FILL MATERIAL IS DEPOSITED ONTO THE ROADS USED BY DELIVERY TRUCKS. ANY MATERIAL DEPOSITED ONTO ROADWAYS SHALL BE CLEANED AS NECESSARY TO AVOID CAUSING NUISANCE TO VEHICLE TRAFFIC.
- ALL WORK SHALL BE IN ACCORDANCE WITH IPSWICH CITY COUNCIL DESIGN STANDARDS.
- ALL EARTHWORKS & WORKS ASSOCIATED WITH PROPOSED DEVELOPMENT SHALL BE UNDERTAKEN IN STRICT ACCORDANCE WITH THE PROJECT SPECIFIC GEOTECHNICAL REPORT AND AS3978.
- WORKS MUST BE UNDERTAKEN IN ACCORDANCE WITH BUTLER PARTNERS REPORTS 010-218K - '633 RIPLEY ROAD' & '695 AND 787-815 RIPLEY ROAD' 31/01/2021
- WHERE NEW WORK ABUTS EXISTING WORK THE CONTRACTOR SHALL ENSURE THAT A SMOOTH EVEN PROFILE, FREE FROM ABRUPT CHANGES IS OBTAINED.
- THE PLACEMENT OF ALL FILL TO BE INSPECTED, TESTED AND CERTIFIED BY A GEOTECHNICAL ENGINEER TO A LEVEL 1 REQUIREMENT DURING THE EARTHWORKS OPERATIONS TO ENSURE THAT ALL FILL IS PLACED IN A "CONTROLLED MANNER", IN ACCORDANCE WITH AS3798 "GUIDELINES ON EARTHWORKS FOR COMMERCIAL AND RESIDENTIAL DEVELOPMENTS".
- THE CONTRACTOR IS RESPONSIBLE FOR ENGAGING A NATA ACCREDITED GEOTECHNICAL CONSULTANT TO SUPERVISE ALL EARTHWORKS PROCEDURES AND PROVIDE LEVEL 1 TESTING AND CERTIFICATION IN ACCORDANCE WITH THE REQUIREMENTS OF AS3798.
- STRIPPED TOPSOIL SHALL BE STOCKPILED WITHIN THE DEVELOPMENT SITE IN A POSITION APPROVED BY THE SUPERINTENDENT.
- ANY IMPORTED FILL SHALL BE APPROVED AND FREE OF ORGANIC MATTER WITH CERTIFICATES PROVIDED
- FILL SHALL BE PLACED IN MAXIMUM 150mm LAYERS

LOCATION	MINIMUM DRY DENSITY RATIO (%)
BUILDING PADS	REFER SITE SPECIFIC GEOTECHNICAL REPORT RECOMMENDATIONS
ROADWAYS	
a) >0.5m BELOW PAVEMENT SUBGRADE	95 (Std.)
b) <0.5m BELOW PAVEMENT SUBGRADE	100 (Std.)
NOTE: THE RECOMMENDED COMPACTIONS ARE PERCENTAGES OF THE MAXIMUM DRY DENSITY DETERMINED BY AUSTRALIAN STANDARD 1289	

ROAD CONSTRUCTION

- CONCRETE WORKS TO BE CONSTRUCTED IN ACCORDANCE WITH AS3600 AND RELEVANT AUTHORITY STANDARDS.
- ONCE EXCAVATION TO SUBGRADE LEVEL HAS OCCURRED, CONTRACTOR TO PROVIDE CBR TEST RESULTS TO SUPERINTENDENT FOR FINAL PAVEMENT DESIGN CONFIRMATION.
- PRIOR TO PLACING EACH LAYER OF PAVEMENT, COMPACTION TEST RESULTS ARE TO BE PROVIDED TO SUPERINTENDENT FOR ACCEPTANCE.
- CONSTRUCTION OF KERB TO BE IN ACCORDANCE WITH RELEVANT COUNCIL STANDARDS.
- ALL SERVICE CONDUIT TRENCHES UNDER ROAD PAVEMENTS TO BE BACKFILLED IN ACCORDANCE WITH RELEVANT MUNICIPALITY OR ROAD AUTHORITY SPECIFICATION. TESTING TO OCCUR AT MINIMUM 40m INTERVALS- 1 TEST FOR EVERY 2 LAYERS.

LOCATION	DENSITY RATIO (%)	TYPE
PAVEMENT	95	MODIFIED MAXIMUM DRY DENSITY
ROADWAYS		
a) >0.5m BELOW PAVEMENT SUBGRADE	95	STANDARD MAXIMUM DRY DENSITY
b) <0.5m BELOW PAVEMENT SUBGRADE	100	STANDARD MAXIMUM DRY DENSITY

GENERAL STORMWATER DRAINAGE

- AG/SUBSOIL DRAIN TO BE LAID BEHIND KERB WHERE REQUIRED IN ACCORDANCE WITH THE COUNCIL STANDARD DRAWINGS AND CONNECTED TO UNDERGROUND DRAINAGE WITH CLEANOUTS AS REQUIRED.
- ALL STORMWATER DRAINS ARE TO BE CLASS '2' R.C. PIPES UNLESS OTHERWISE SHOWN.
- ALL PIPES ≤600 DIAMETER TO BE RUBBER RING JOINTED (R.R.J.) UNLESS STATED OTHERWISE. ALL OTHER PIPES TO BE FLUSH JOINTED (F.J.) UNLESS STATED OTHERWISE.
- ALL DRAINAGE AND DRAINAGE STRUCTURES TO BE IN ACCORDANCE WITH COUNCIL STANDARDS WITH THE INSTALLATION OF HEAVY DUTY LIDS.
- CONCRETE WORKS TO BE CONSTRUCTED IN ACCORDANCE WITH AS3600 AND RELEVANT AUTHORITY STANDARDS.

PAVEMENT

- PAVEMENT DEPTHS MAY BE MODIFIED AS DIRECTED BY THE SUPERINTENDENT. PAVEMENT TO BE BOXED OUT TO MINIMUM DEPTH DENOTED, INSPECTED AND IF SUBGRADE IS IN QUESTION, FURTHER TESTING CARRIED OUT TO DETERMINE FINAL PAVEMENT DEPTH.
- WHERE PAVEMENT IS CONSTRUCTED ON FILLING, FILL MATERIAL IS TO BE APPROVED BY THE SUPERINTENDENT AND COUNCIL. FILLING TO BE CONSTRUCTED IN LAYERS 150mm THICK WITH COMPACTION ACHIEVING 95% AUSTRALIAN STANDARD DENSITY.
- WHEN PAVEMENT EXCAVATION IS IN ROCK ALL LOOSE MATERIAL (INCLUDING ROCKS AND CLAY) MUST BE REMOVED. THE SUB-GRADE MUST THEN BE REGULATED WITH COUNCIL APPROVED MATERIAL.

SIGNAGE AND LINEMARKING

- LINEMARKING AND SIGNAGE TO BE INSTALLED IN ACCORDANCE WITH AS 1742 SERIES UNLESS NOTED OTHERWISE. STREET SIGNS ARE TO BE INSTALLED IN ACCORDANCE WITH COUNCIL/AUTHORITY STANDARDS.
- ALL TEMPORARY WARNING SIGNS USED DURING CONSTRUCTION SHALL BE SUPPLIED AND MAINTAINED IN ACCORDANCE WITH AS 1742
- TACTILE GROUND SURFACE INDICATORS ARE TO BE INSTALLED IN ACCORDANCE WITH THE DISABILITY DISCRIMINATION ACT AND RELEVANT COUNCIL STANDARD DRAWINGS.

CONCRETE

- CONCRETE WORKS TO BE CONSTRUCTED IN ACCORDANCE WITH AS3600 AND RELEVANT AUTHORITY STANDARDS.

RETAINING WALLS

- RETAINING WALLS SHOWN ON THESE CIVIL DRAWINGS INDICATE ONLY THE RETAINING WALL TYPE, LOCATION, HEIGHT AND RELATIVITY TO BOUNDARIES OR OTHER KNOWN ELEMENTS. ALL RETAINING WALL STRUCTURAL AND OTHER SPECIFICATION SHALL BE DETAILED BY OTHERS. THE APPOINTED CONTRACTOR SHALL REVIEW ALL DEVELOPMENT APPROVAL CONDITIONS, PLANS AND SPECIFICATIONS TO ENSURE THAT ALL RETAINING WALL LOADS, ANCILLARY DRAINAGE (SUBSOIL & SURFACE DRAINAGE) AND CONSTRAINTS ARE ACCOMMODATED (INCLUDING ANY FUTURE FENCES WHICH MAY BE ATTACHED), AND SHALL SUPPLY THE SUPERVISING ENGINEER ALL POST-CONSTRUCTION CERTIFICATIONS NECESSARY FOR RELEVANT LOCAL AUTHORITY ACCEPTANCE. FOR WORKS WITHIN QUEENSLAND THIS SHALL INCLUDE (BUT NOT LIMITED TO) QUEENSLAND GOVERNMENT - "FORM 15" AND "FORM 12" CERTIFIED BY AN R.P.E.Q. ENGINEER.

LEGEND

DESCRIPTION	EXISTING	PROPOSED
WATER MAIN	--- Dw ---	--- Dw ---
ELECTRICITY	--- E ---	--- E ---
TELECOMMUNICATIONS & SERVICE PIT	--- T ---	--- T ---
GAS MAIN	--- G ---	--- G ---
SEWER & MAINTENANCE STRUCTURE	--- S ---	--- S ---
SWALE	--- SWD ---	--- SWD ---
STORMWATER DRAIN & PIT	--- SWD ---	--- SWD ---
STORMWATER PITS	--- SWD ---	--- SWD ---
AG DRAIN AND FLUSHER	--- AG ---	--- AG ---
STORM WATER DRAINAGE PIT NUMBER	--- SWD ---	--- SWD ---
BARRIER KERB - TYPE B1	--- B1 ---	--- B1 ---
BARRIER KERB - TYPE B2	--- B2 ---	--- B2 ---
INVERT - TYPE CHANNEL	--- C1 ---	--- C1 ---
EDGE RESTRAINT - TYPE ER2	--- ER2 ---	--- ER2 ---
MOUNTABLE KERB - TYPE 1	--- TYPE 1 ---	--- TYPE 1 ---
SURFACE CONTOUR MAJOR	--- 169.00 ---	--- 169.00 ---
SURFACE CONTOUR MINOR	--- 168.90 ---	--- 168.90 ---
SIGN AND POST	--- SIGN ---	--- SIGN ---
LIGHT & POLE (BY OTHERS)	--- LIGHT ---	--- LIGHT ---
STREET SIGN	--- STREET ---	--- STREET ---
ROAD CENTERLINE	--- CH200.000 ---	--- CH200.000 ---
ROAD CHAINAGES	--- CH200.000 ---	--- CH200.000 ---
LIMIT OF WORKS	--- LIMIT ---	--- LIMIT ---
BATTER	--- BATTER ---	--- BATTER ---
CUT EXTENTS	--- CUT ---	--- CUT ---
FILL EXTENTS	--- FILL ---	--- FILL ---
ROCK PITCHING	--- ROCK ---	--- ROCK ---
FENCES	--- FENCE ---	--- FENCE ---
GUARD RAIL	--- GUARD ---	--- GUARD ---
TREE	--- TREE ---	--- TREE ---
ROAD PAVEMENT - TYPE A	--- ROAD ---	--- ROAD ---
ROAD PAVEMENT - TYPE B	--- ROAD ---	--- ROAD ---
FOOTPATH	--- FOOT ---	--- FOOT ---
RETAINING WALL	--- RETAIN ---	--- RETAIN ---
RETAINING WALL HEIGHT		(2.0)

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Rev	Description	Approved	Date
B	ISSUE FOR TENDER	K.H.	21-02-24
A	ISSUE FOR APPROVAL	K.H.	01-12-23
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AMORY AT RIPLEY

STAGE 01

GENERAL NOTES & LEGEND


 IPSWICH CITY COUNCIL

 RIPLEY ROAD DEVELOPMENT PTY LTD

PRELIMINARY

 Drg No: 320678-01C0101 Rev: B

LAYOUT PLAN - SHEET 1

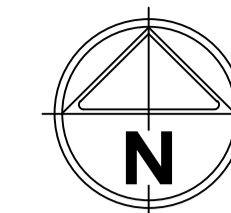

FUTURE STAGES

FUTURE STAGES

OVERALL KEY PLAN

SCALE 1:500

FUTURE STAGE 1B

LAYOUT PLAN - SHEET 2

WARNING

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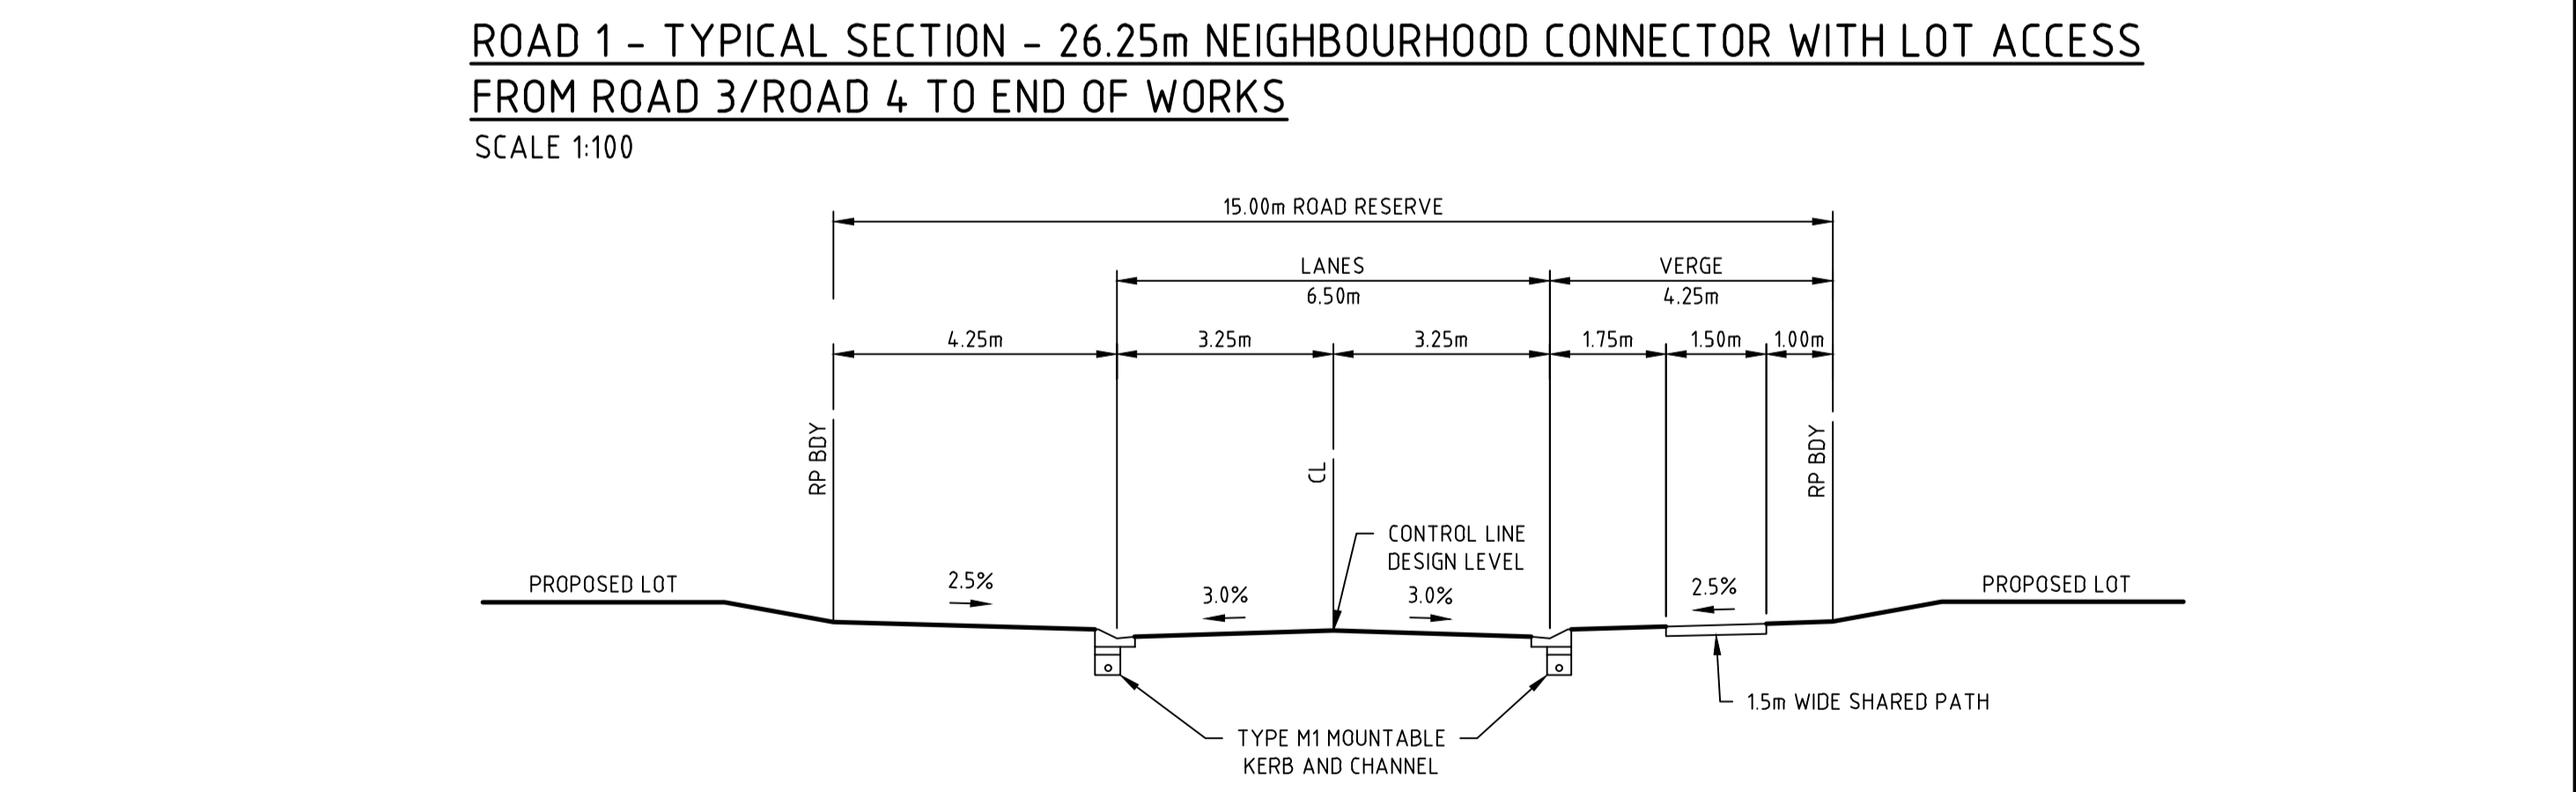
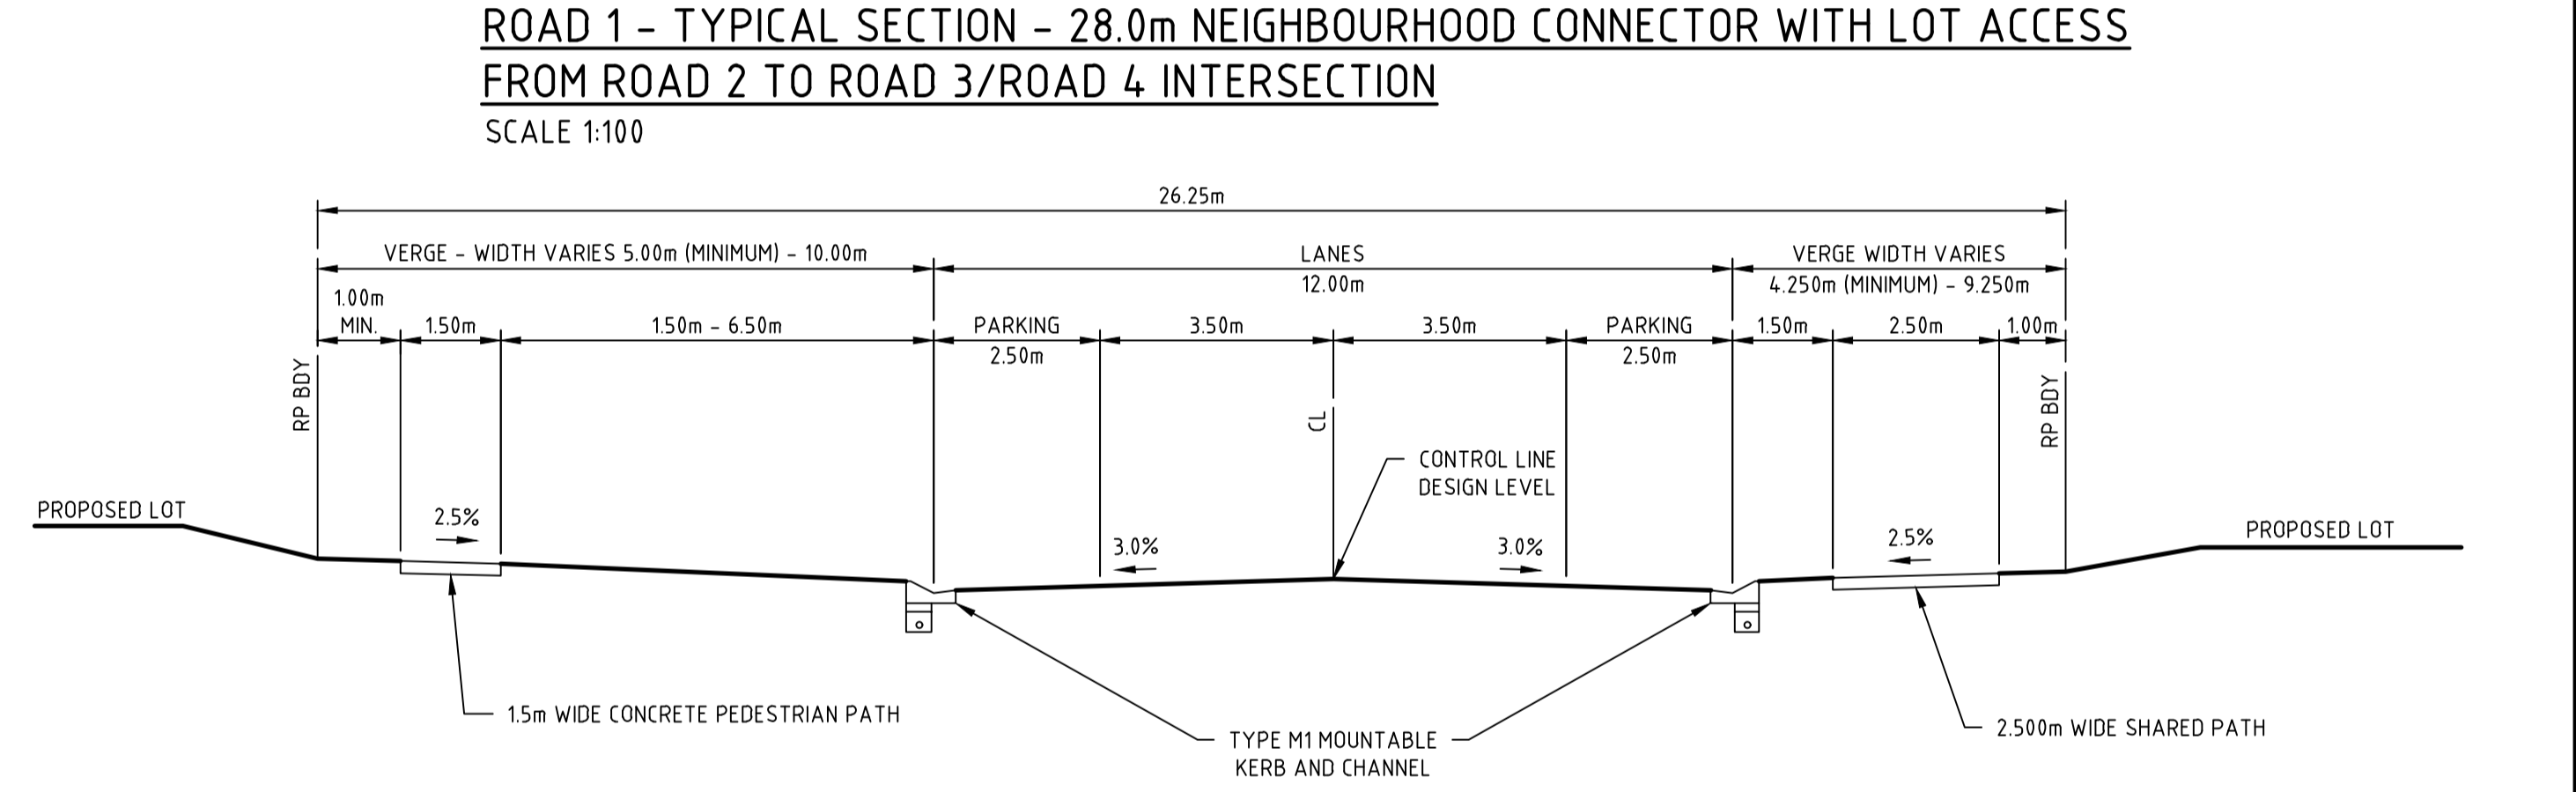
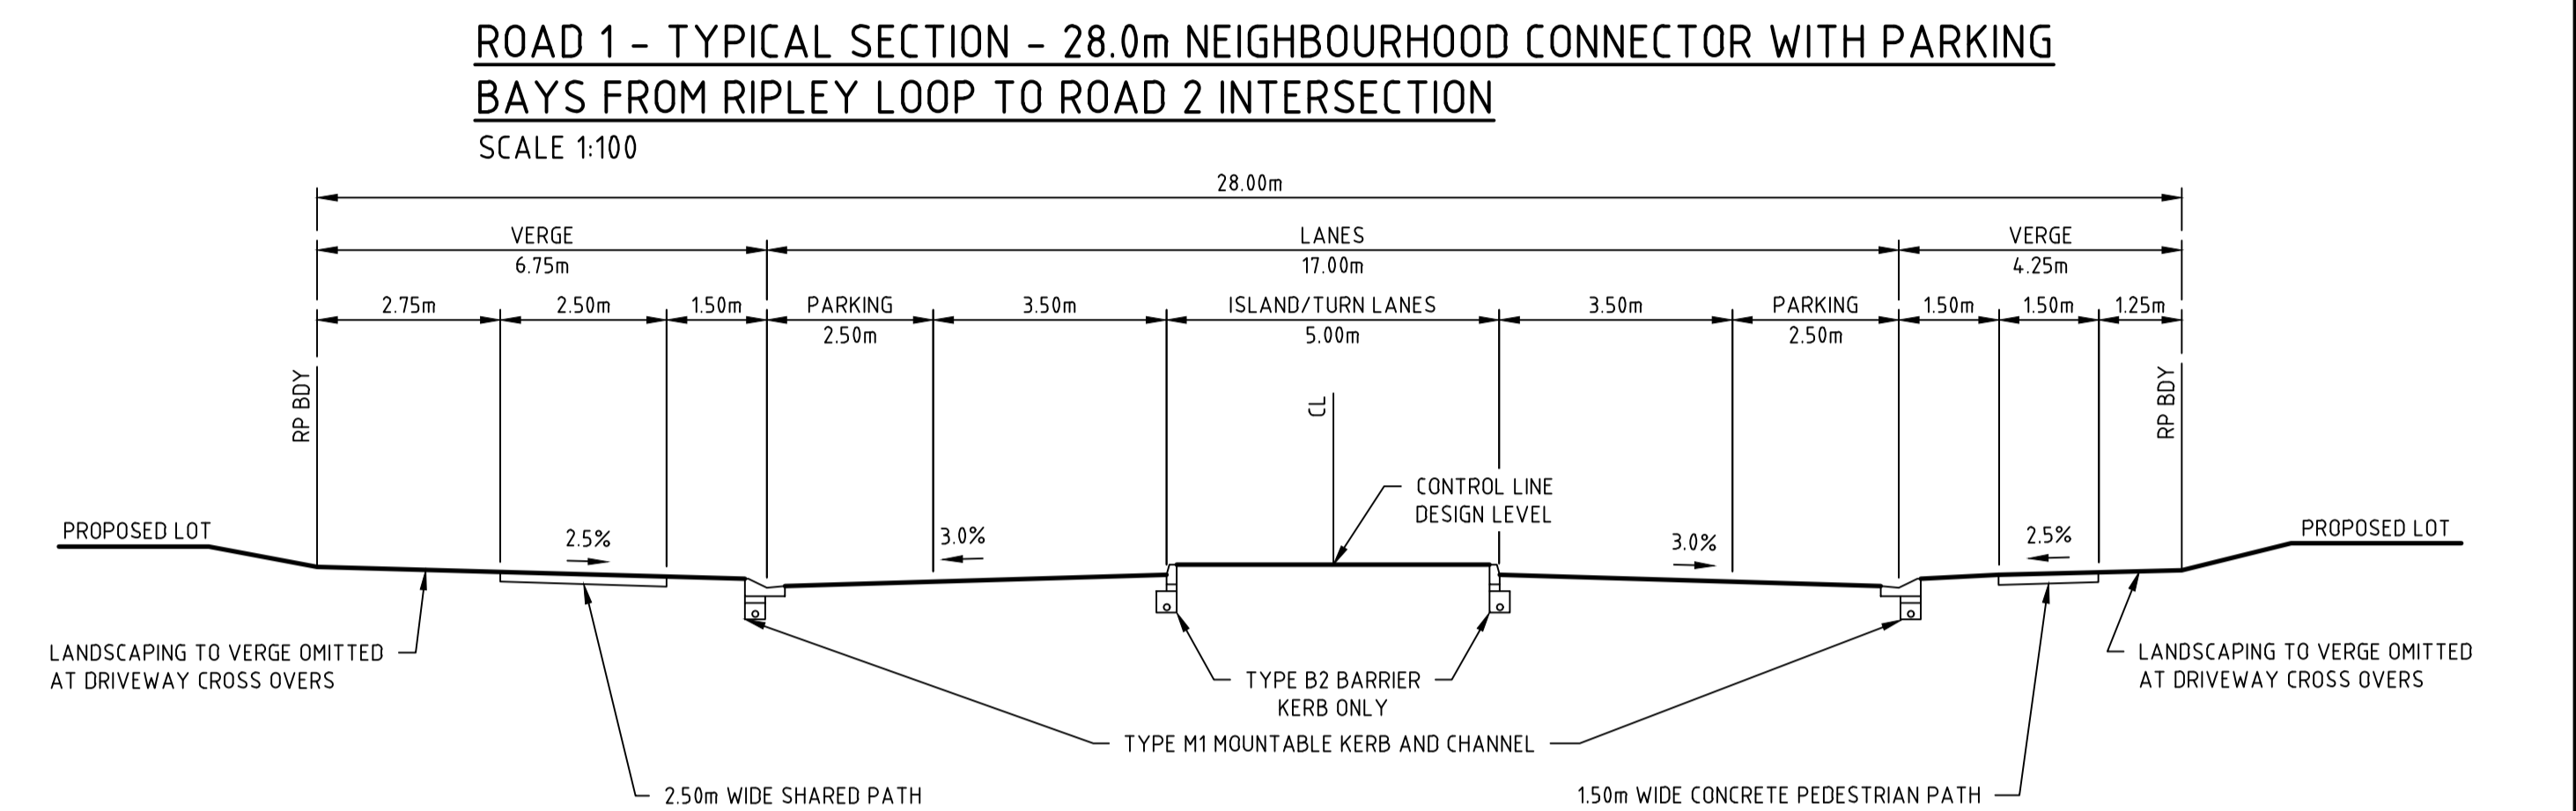
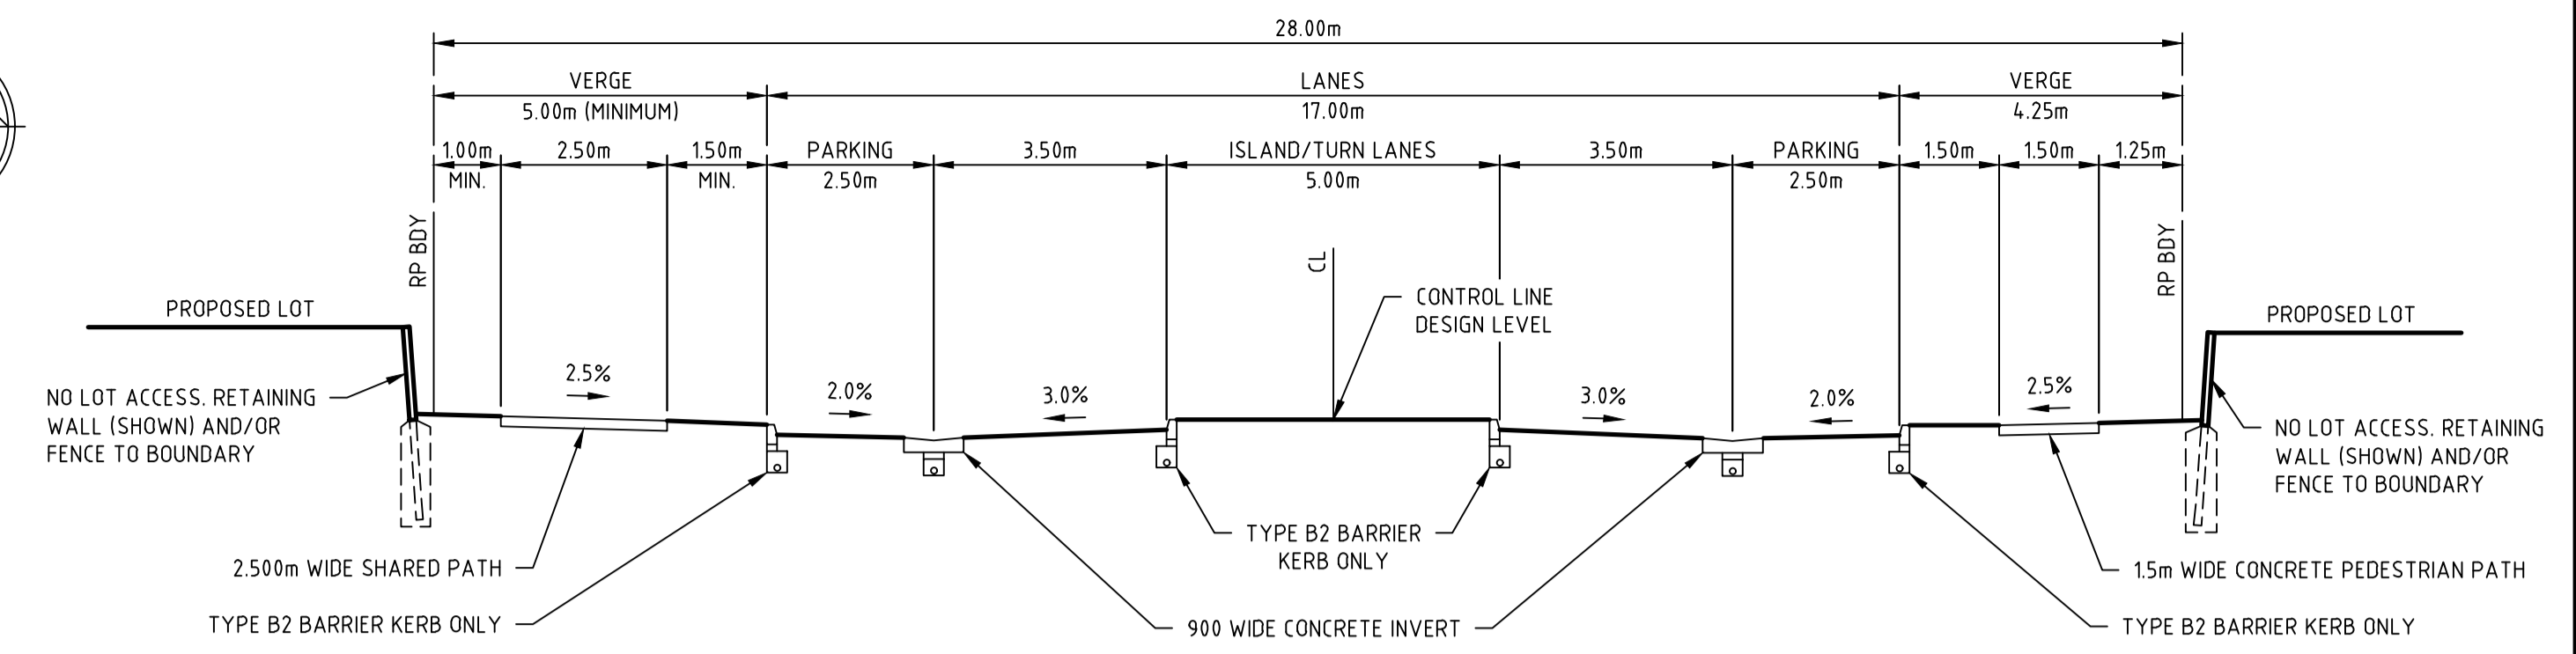
**AMORY AT RIPLEY
 STAGE 01
 OVERALL KEY PLAN**

IPSWICH CITY COUNCIL
 RIPLEY ROAD DEVELOPMENT PTY LTD

PRELIMINARY Drg No 320678-01C0102 Rev B


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B	ISSUE FOR TENDER	K.H.	21-02-24
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ROAD 2 - CH.000 TO CH 121.500
ROAD 3 - CH.000 TO CH 46.750
ROAD 4 - CH.000 TO CH 64.500
SCALE 1:100

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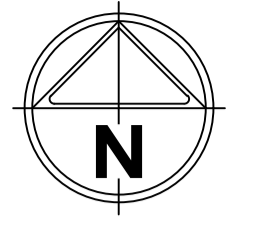
AMORY
AT RIPLEY

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DECEMBER 23

AMORY AT RIPLEY
STAGE 01
CONTROL LINE LAYOUT PLAN
AND TYPICAL ROAD SECTIONS
IPSWICH CITY COUNCIL
RIPLEY ROAD DEVELOPMENT PTY LTD


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BULK EARTHWORKS STAGE 01R.
REFER TO DRAWING SET
320678-01R FOR DETAILS

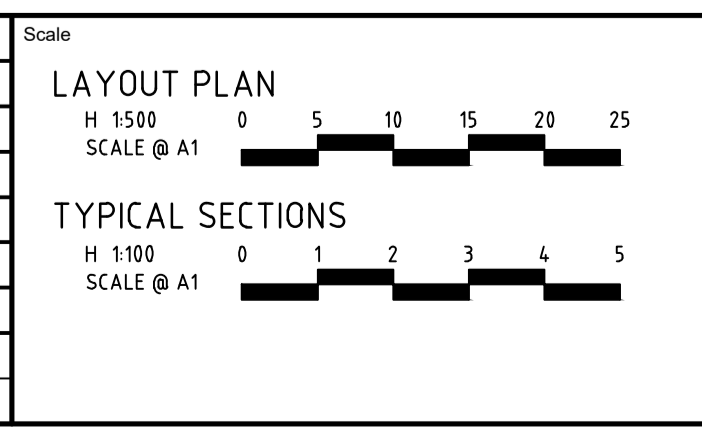BULK EARTHWORKS 'EARLY WORKS'
DESIGN. REFER TO DRAWING SET
320678-BEW FOR DETAILS



CH121.500 END
CH120.000

CH100.000

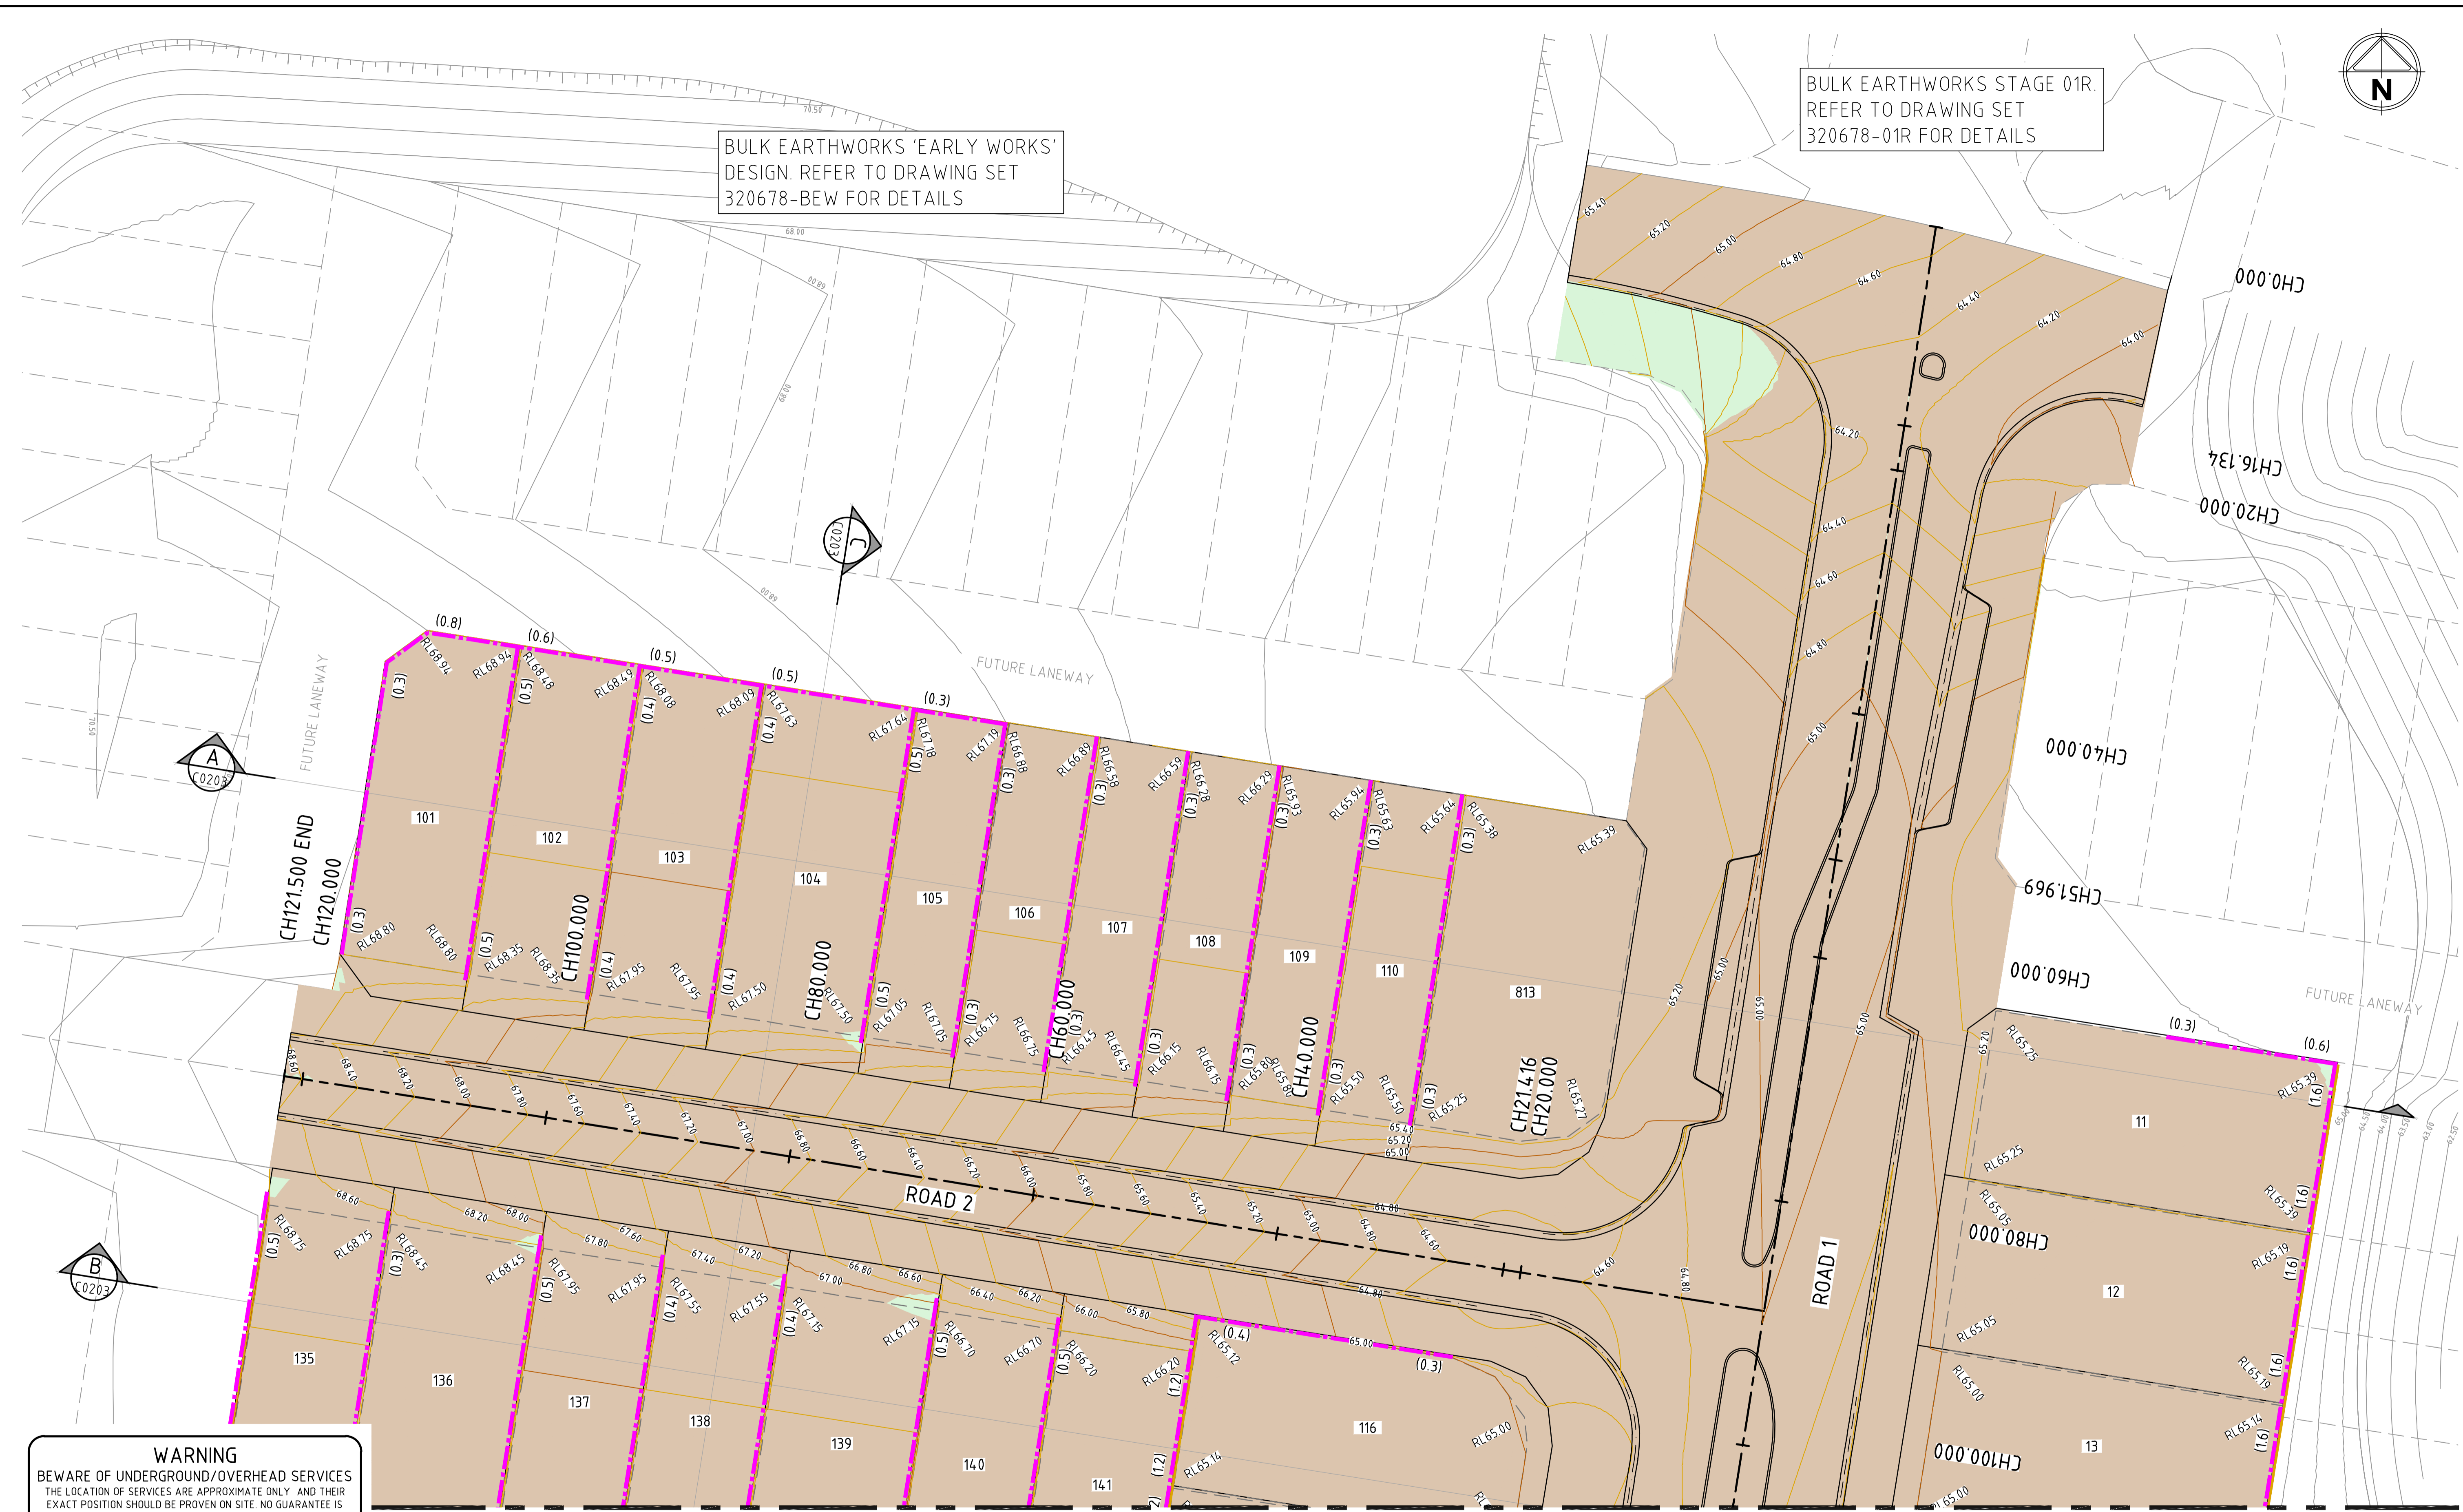CH80.000

CH60.000

CH40.000

CH21.416
CH20.000

CH00.000

CH16.134
CH20.000

CH40.000

CH51.969

CH60.000

CH80.000

CH100.000

WARNING
BEWARE OF UNDERGROUND/OVERHEAD SERVICES
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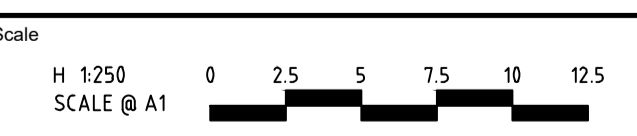
EARTHWORKS LAYOUT PLAN - SHEET 2 OF 2

SCALE 1:250

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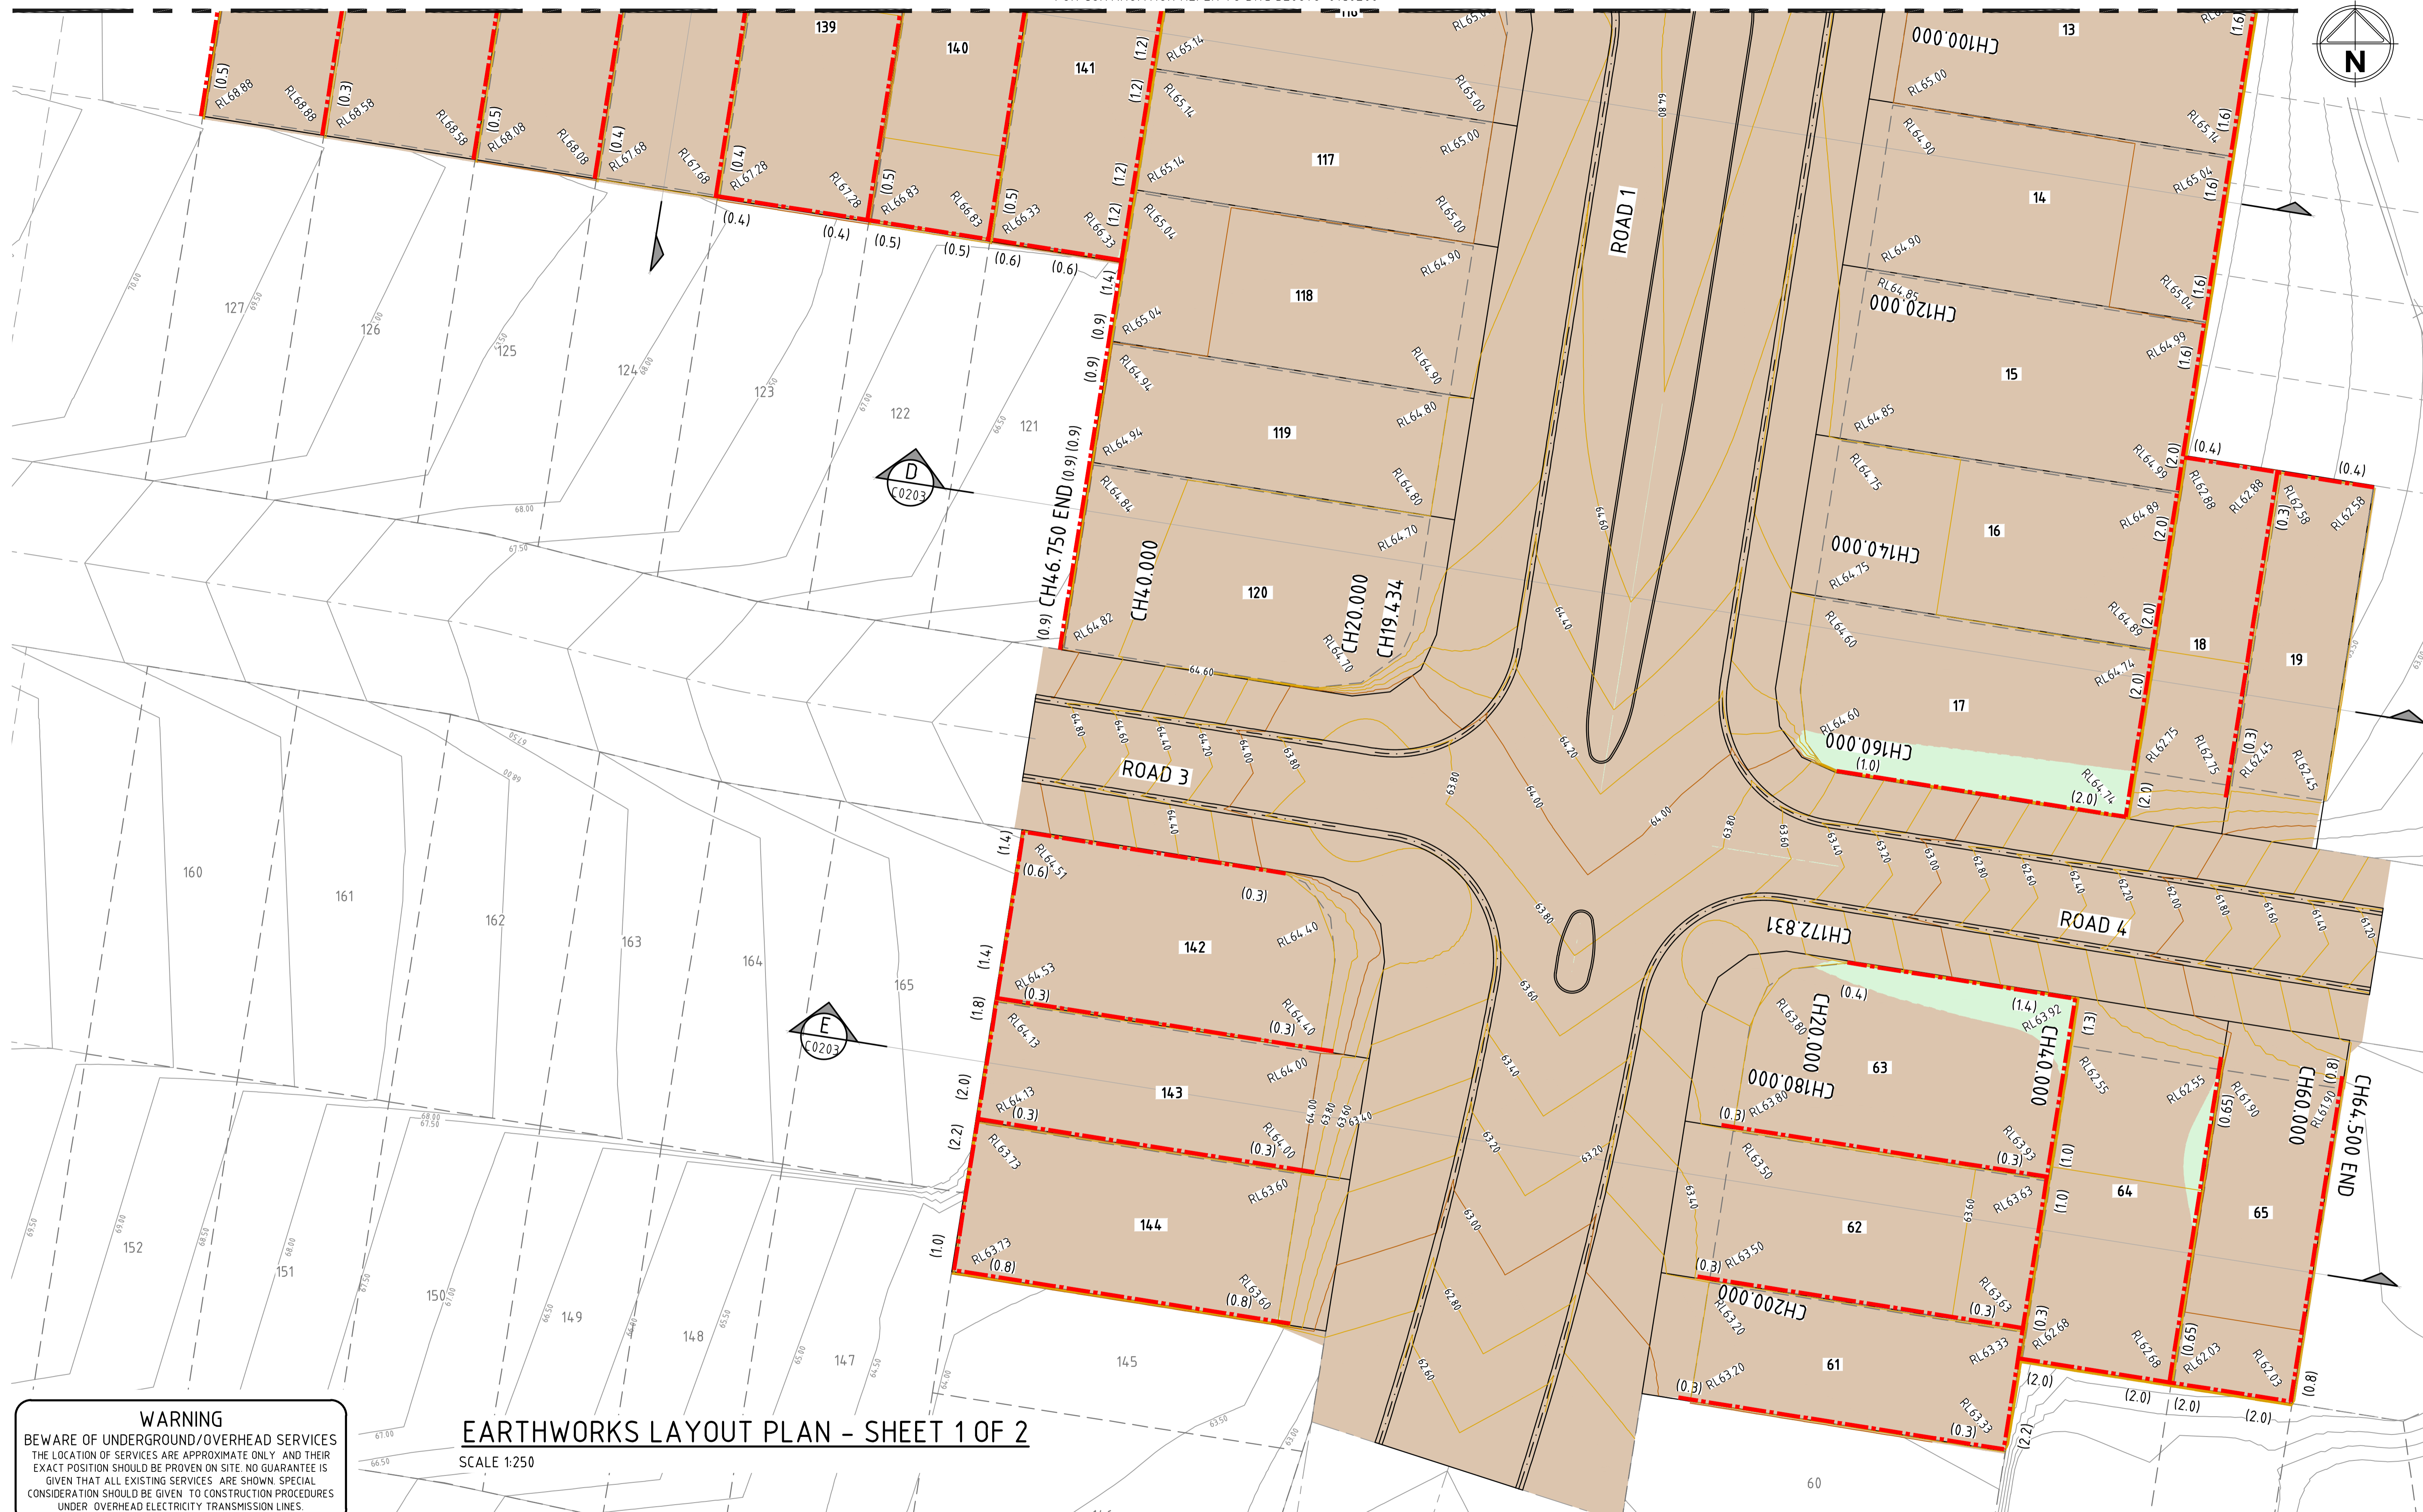
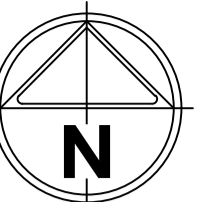


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AMORY AT RIPLEY
STAGE 01
EARTHWORKS LAYOUT PLAN
SHEET 1 OF 2
IPSWICH CITY COUNCIL
RIPLEY ROAD DEVELOPMENT PTY LTD
PRELIMINARY Drg No 320678-01C0200 Rev B




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EARTHWORKS LAYOUT PLAN - SHEET 1 OF 2
 SCALE 1:250

file name: 320678-01C0201.dwg; layout name: C0201; plot by: Michael Bremer; file location: C:\Users\michael_bremer\OneDrive\Documents\320678-01C0201.dwg; sheet # of # sheets: 2

Rev	Description	Approved	Date
B	ISSUE FOR TENDER	K.H.	21-02-24
A	ISSUE FOR APPROVAL	K.H.	01-12-23
	Amendments		

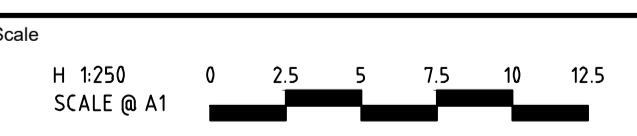

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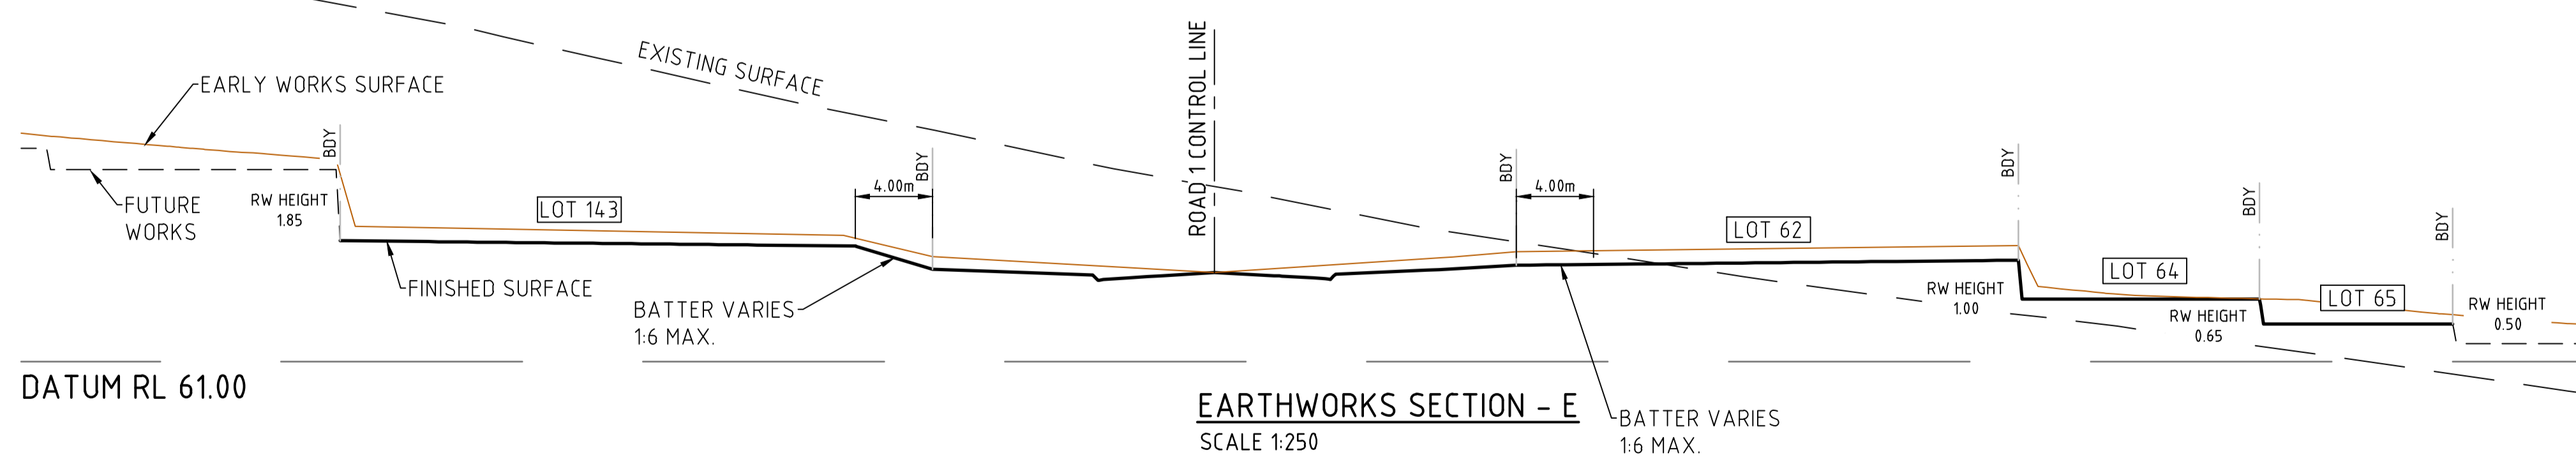
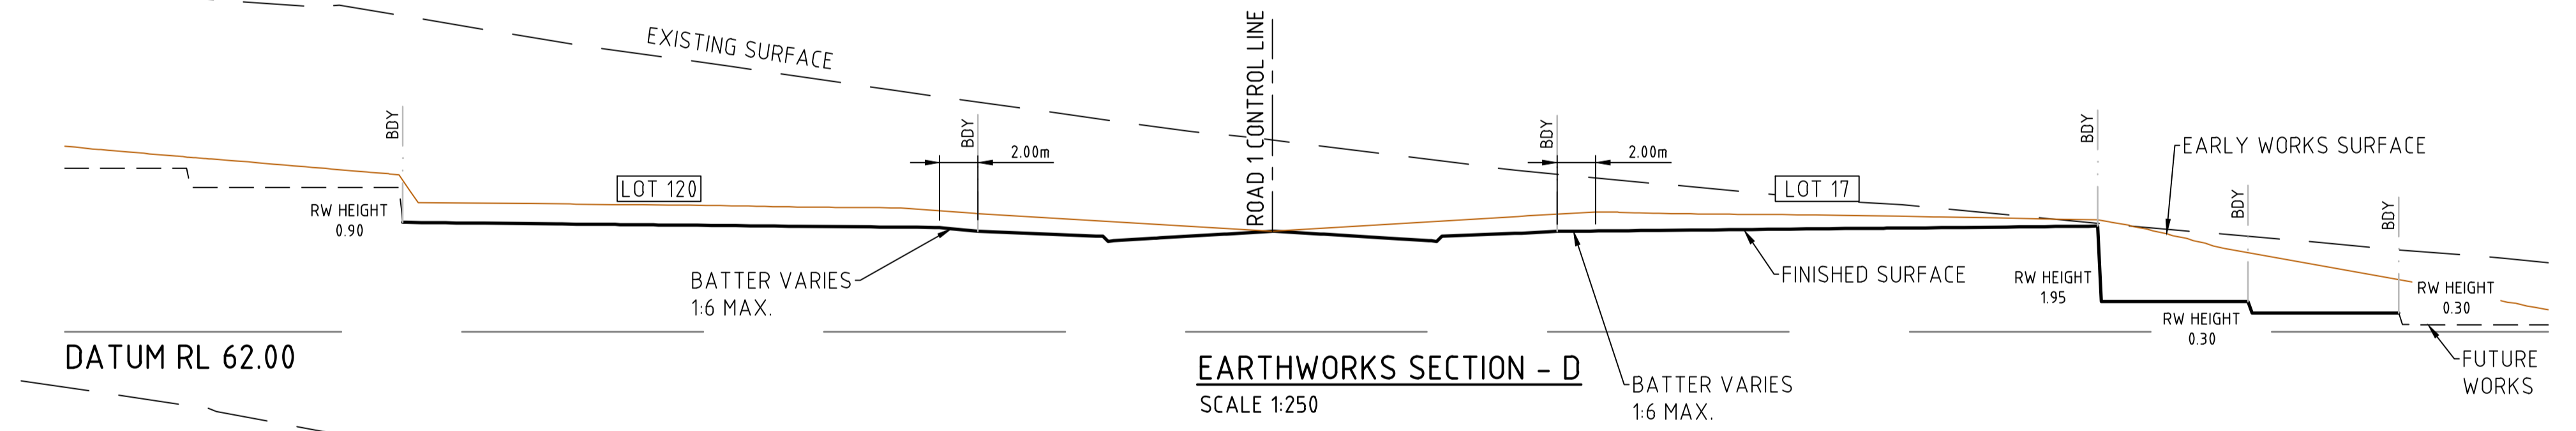
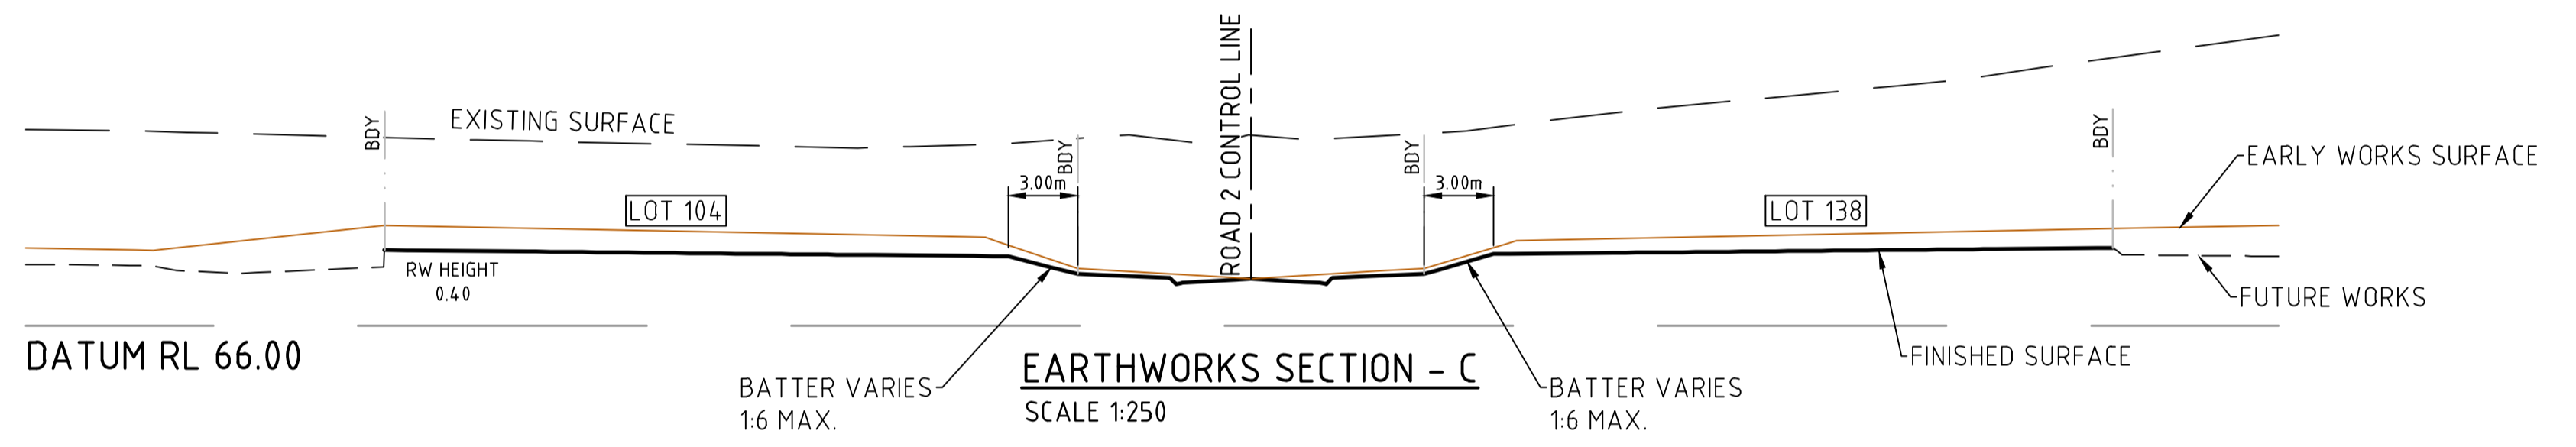
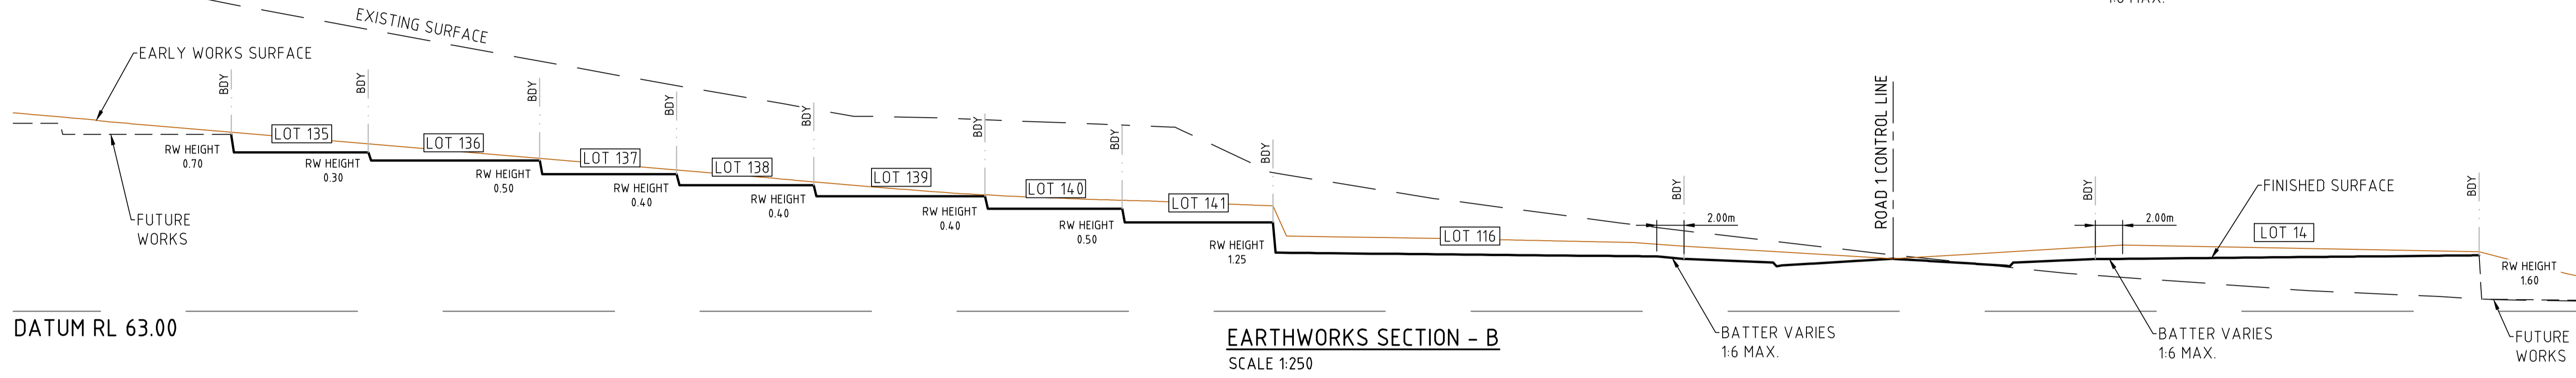
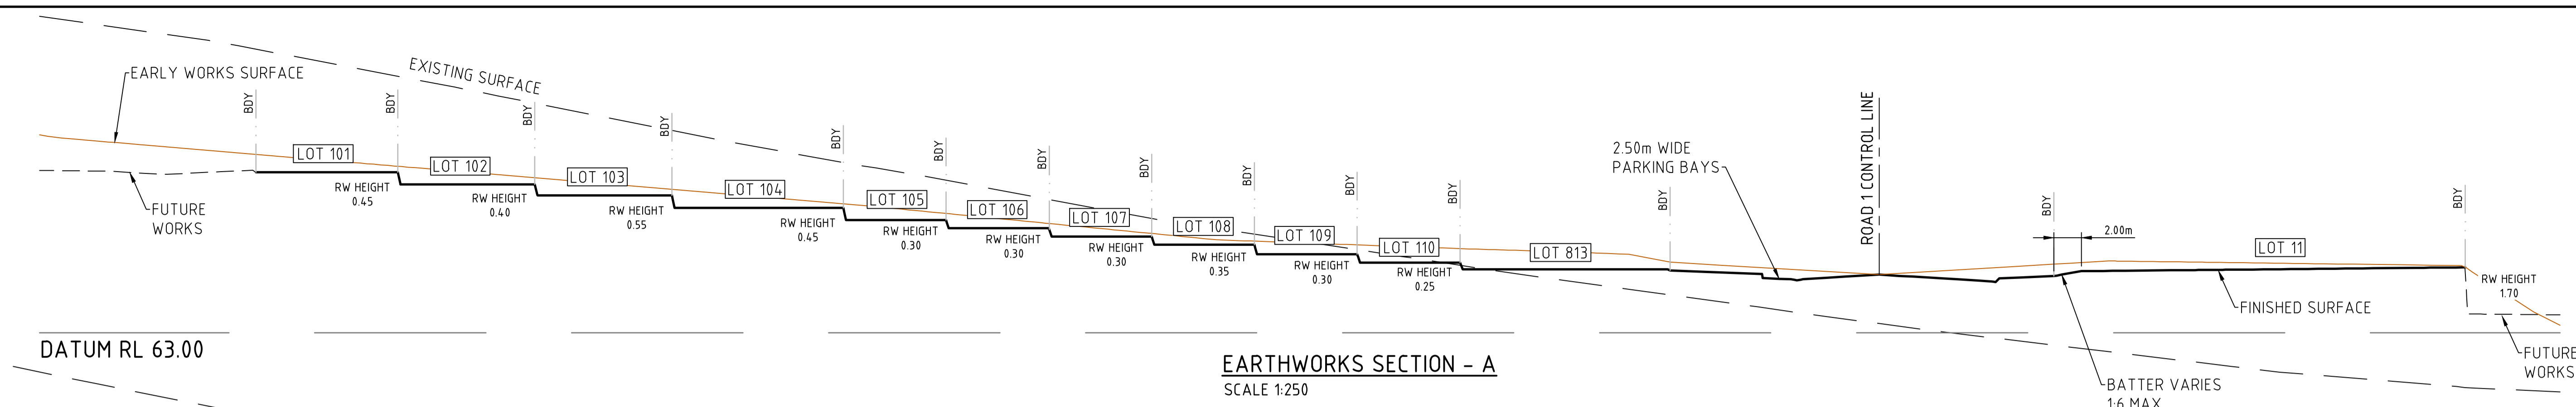
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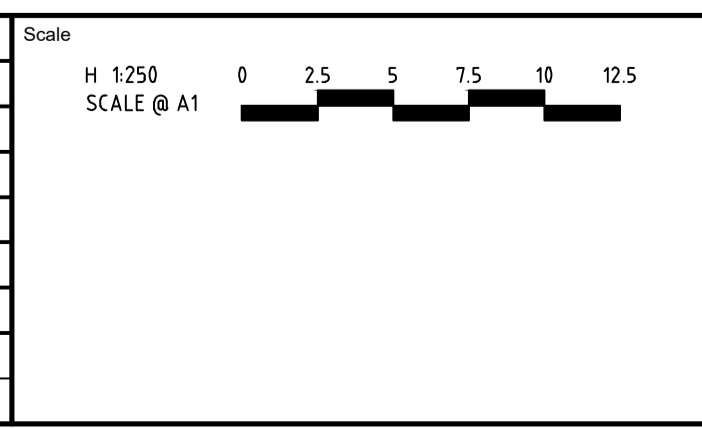
AMORY AT RIPLEY
 STAGE 01
 EARTHWORKS LAYOUT PLAN
 SHEET 2 OF 2
 IPSWICH CITY COUNCIL
 RIPLEY ROAD DEVELOPMENT PTY LTD

PRELIMINARY Drg No 320678-01C0201 Rev B



file name: 320678-01C0202.dwg, layout name: C0202, plotted by: Michael Bremer, file location: C:\Users\michael.bremer\OneDrive - Spiire Australia Pty Ltd\Documents\320678-01C0202.dwg, plot date: 23/12/2024, 3:58 PM, sheet 5 of 9 sheets

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AMORY AT RIPLEY
STAGE 01
EARTHWORKS SITE SECTIONS

IPSWICH CITY COUNCIL
 RIPLEY ROAD DEVELOPMENT PTY LTD

PRELIMINARY Drg No 320678-01C0202 Rev B

DESIGN PAVEMENT PROFILE- TYPE A

PAVEMENT LAYER	DESCRIPTION	DEPTH (mm)
		TYPE A*
WEARING SURFACE	ASPHALT CONCRETE AC14M	50
PRIMER SEAL	AMCO OR AMCO0 PRIME	YES
BASE COURSE	TYPE 2.1 (MIN CBR 80)	125
UPPER PAVEMENT TOTAL		175
UPPER SUBBASE	TYPE 2.3 (MIN CBR 45)	100
LOWER SUBBASE	TYPE 2.5 (MIN CBR 15)	295
TOTAL PAVEMENT DEPTH		570


DESIGN PAVEMENT PROFILE- TYPE B

PAVEMENT LAYER	DESCRIPTION	DEPTH (mm)
		TYPE B*
WEARING SURFACE	ASPHALT CONCRETE AC14M	35
PRIMER SEAL	AMCO OR AMCO0 PRIME	YES
BASE COURSE	TYPE 2.1 (MIN CBR 80)	125
UPPER PAVEMENT TOTAL		160
UPPER SUBBASE	TYPE 2.3 (MIN CBR 45)	100
LOWER SUBBASE	TYPE 2.5 (MIN CBR 15)	155
TOTAL PAVEMENT DEPTH		415

DESIGN PAVEMENT PROFILE- TYPE C

PAVEMENT LAYER	DESCRIPTION	DEPTH (mm)
		TYPE B*
WEARING SURFACE	ASPHALT CONCRETE AC14M	35
PRIMER SEAL	AMCO OR AMCO0 PRIME	YES
BASE COURSE	TYPE 2.1 (MIN CBR 80)	125
UPPER PAVEMENT TOTAL		160
UPPER SUBBASE	TYPE 2.3 (MIN CBR 45)	100
LOWER SUBBASE	TYPE 2.5 (MIN CBR 15)	195
TOTAL PAVEMENT DEPTH		455

ROAD NAME	TYPE
RIPLEY LOOP ROAD	TYPE A
ROAD 1	TYPE C
ROAD 2	TYPE B
ROAD 3	TYPE B
ROAD 4	TYPE B

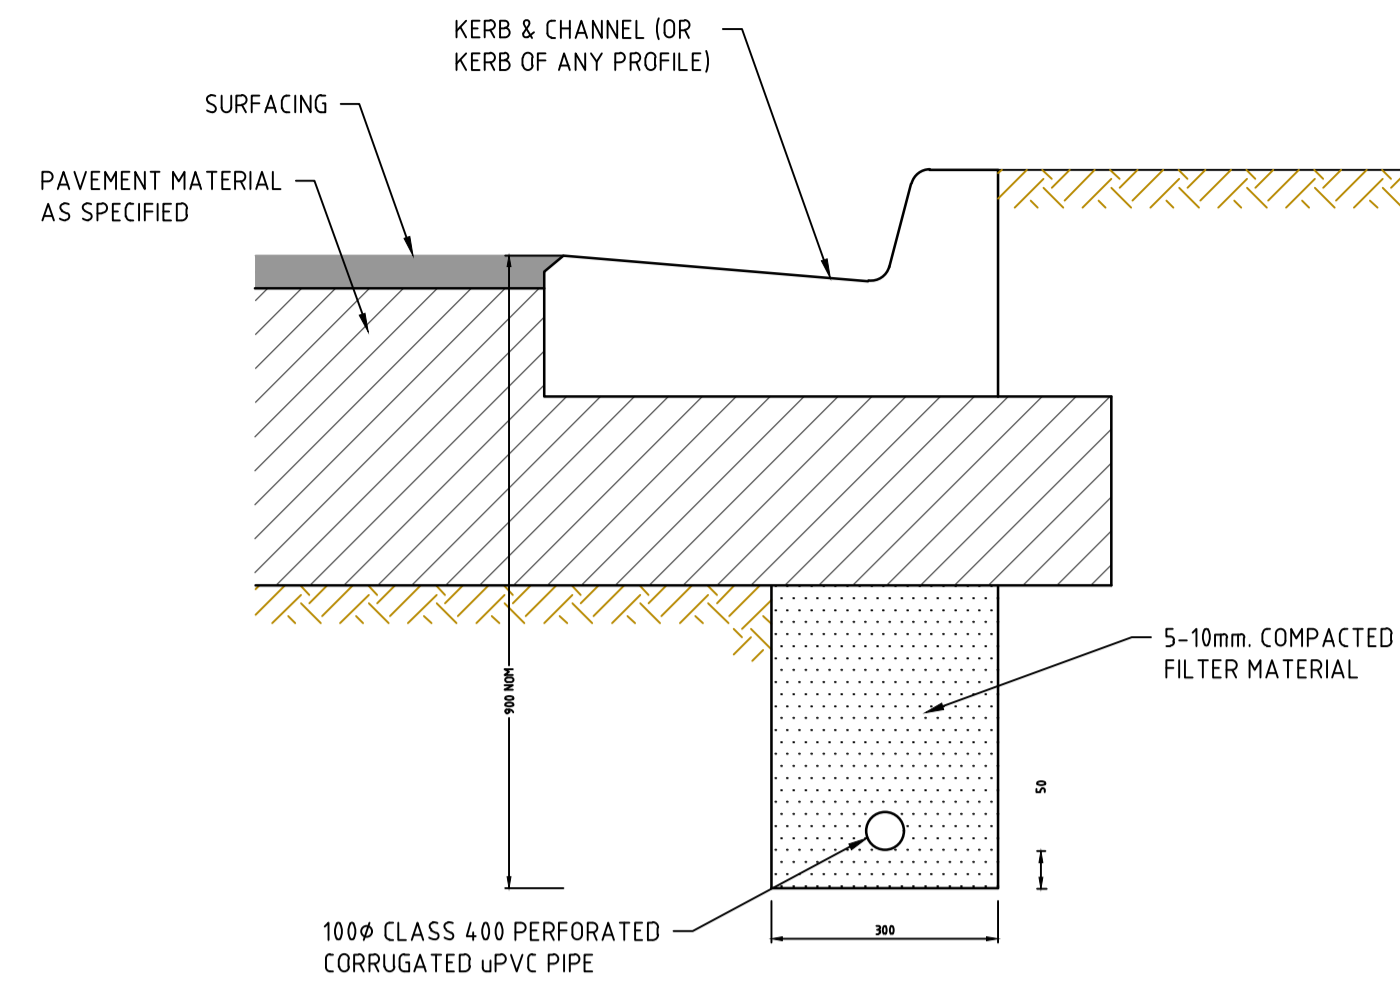

SUBSURFACE PAVEMENT DRAIN

REFER TO ICC STANDARD DWG NO. SR.20
NOT TO SCALE

MEDIAN INFILL


100mm N32 CONCRETE WITH 50mm SAND- REFER IPWEA RS-065

FOOTPATHS


100mm N25 CONCRETE- SL72 50 TOP COVER- REFER ICC SR.19

DRIVEWAYS (FUTURE LANEWAY ACCESS)


175mm N32 CONCRETE WITH SL72 MESH AND 50mm TOP COVER. REFER ICC SR13

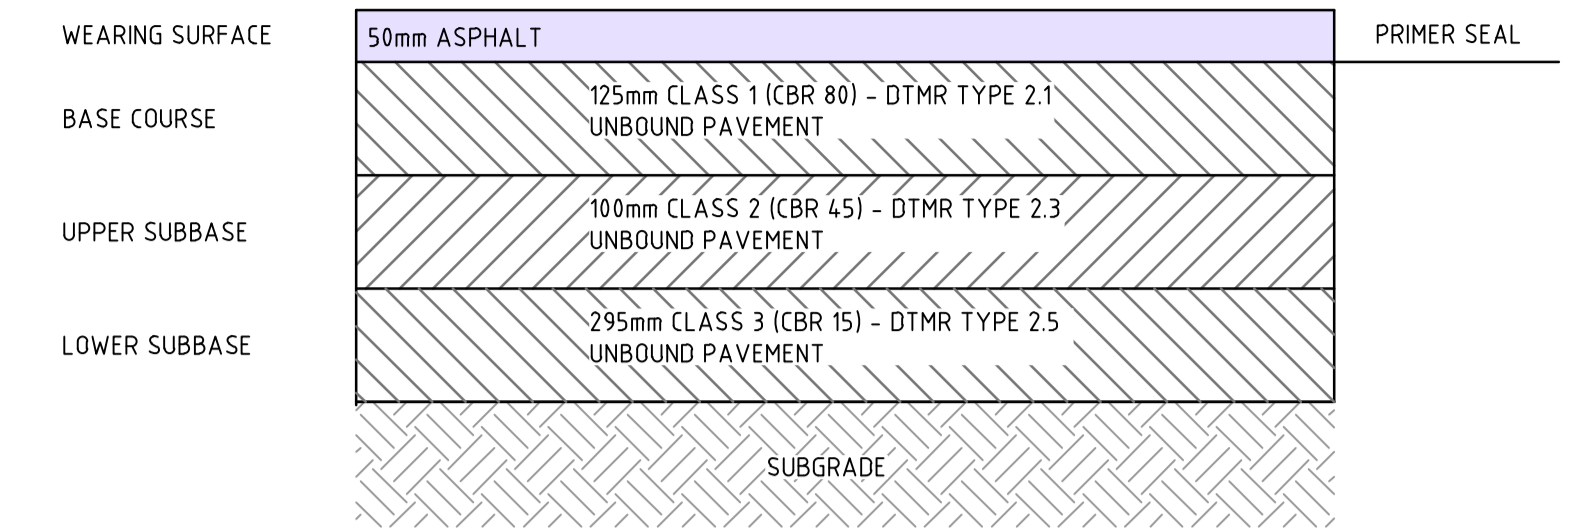


PAVEMENT TYPE A
RIPLEY LOOP

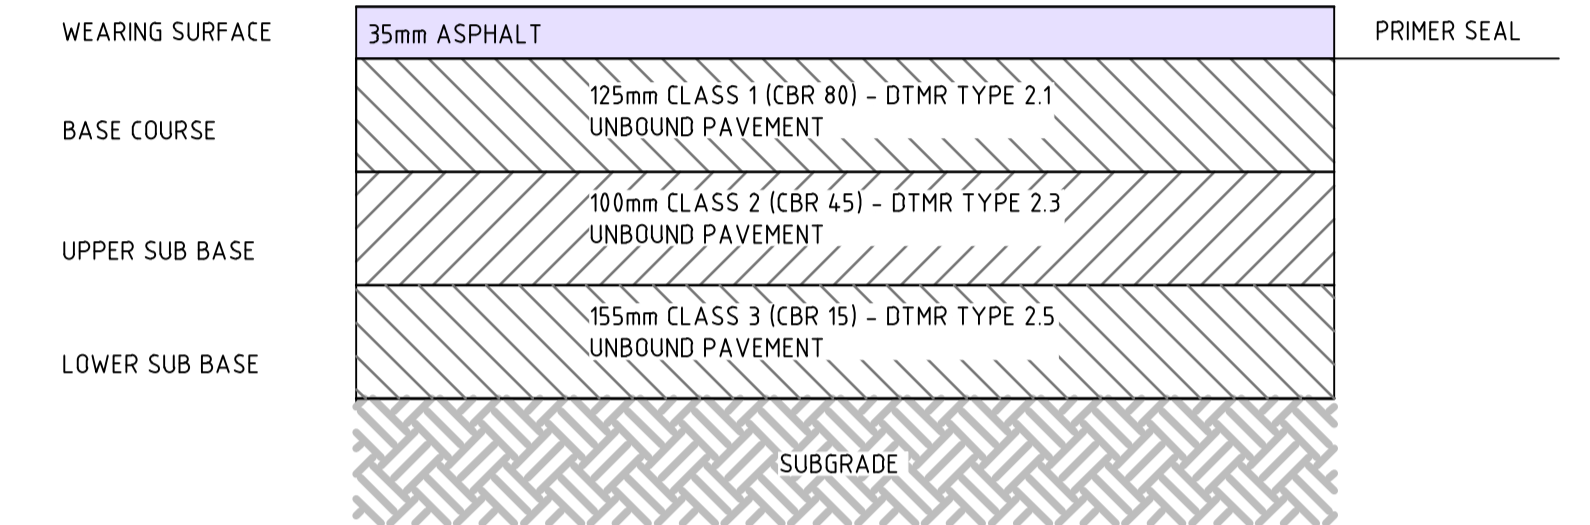

PAVEMENT TYPE B
ROAD 2, 3, 4

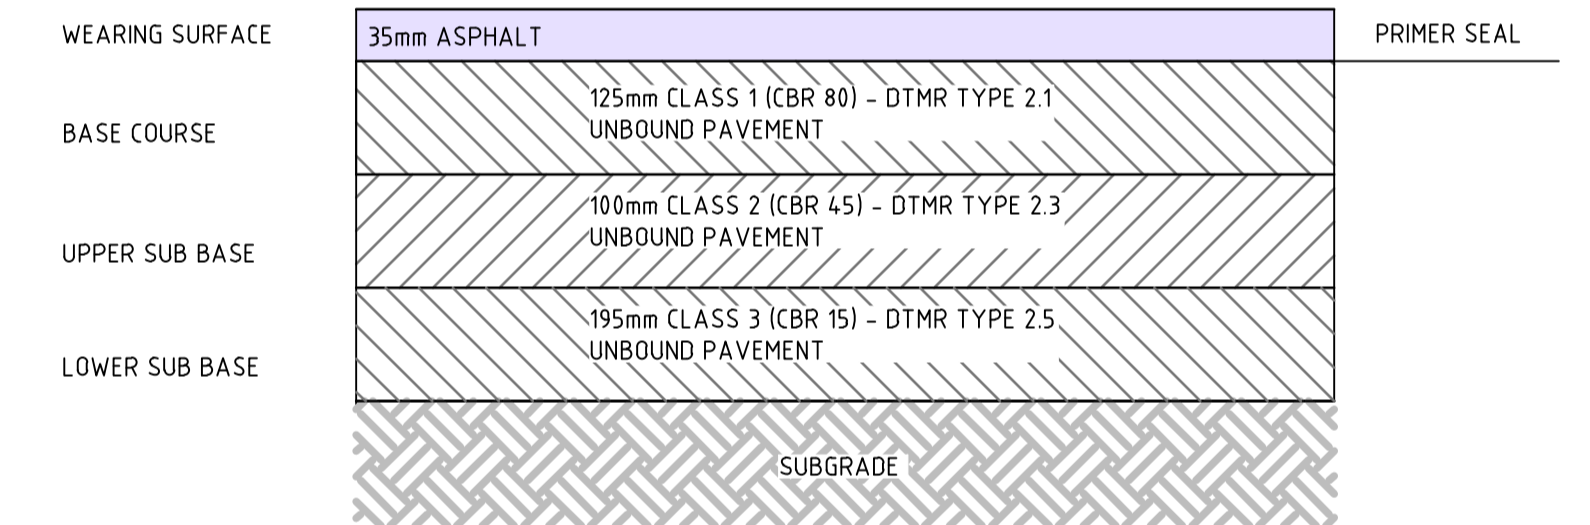

PAVEMENT TYPE C
ROAD 1

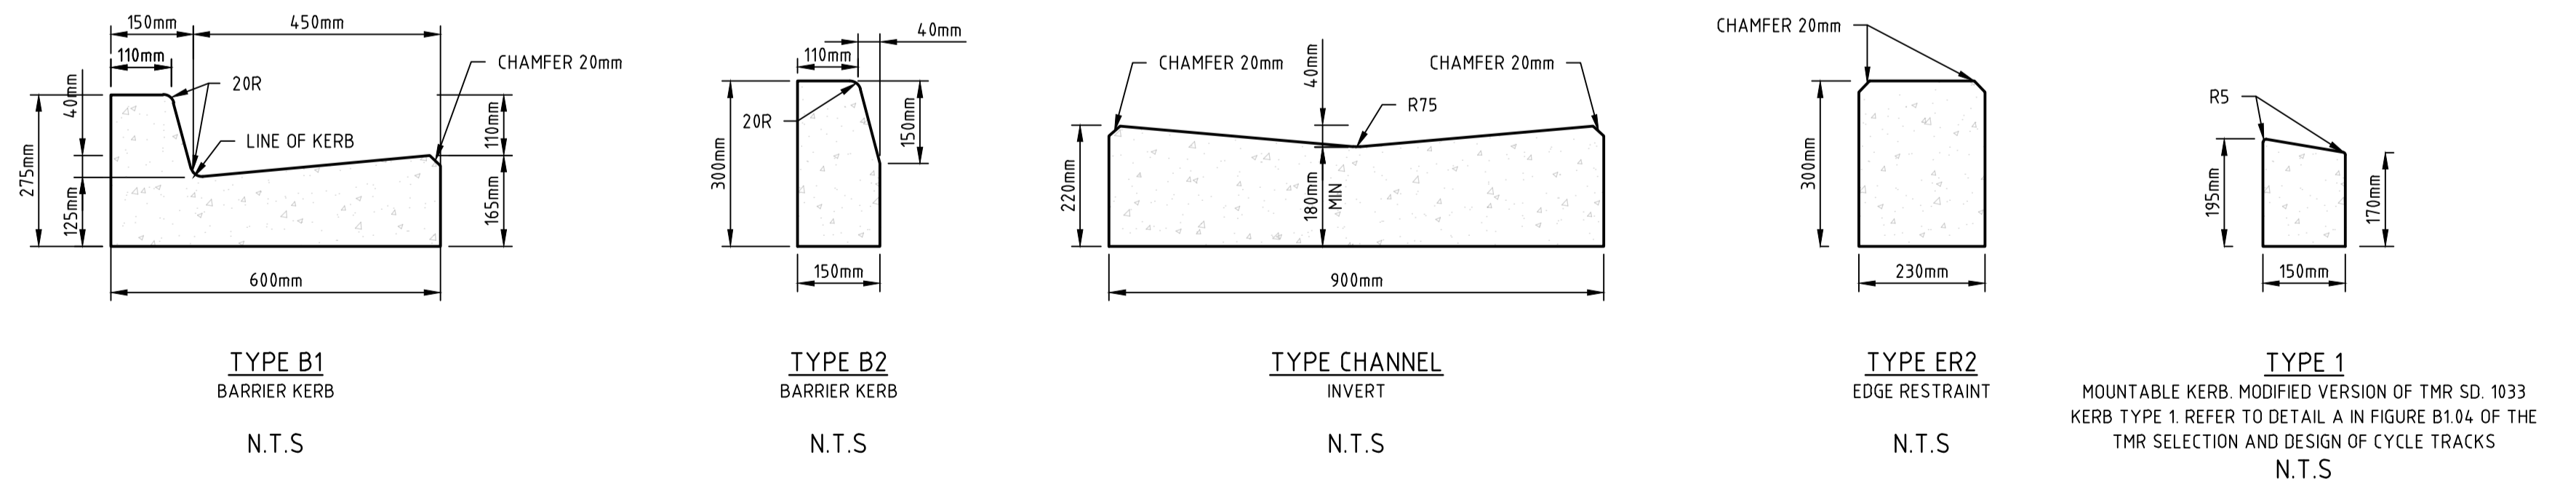

STANDARD KERB PROFILES

NOTE: ALL KERB & CHANNEL AS PER IPWEA STD DRAWING
RS.080 UNLESS STATED OTHERWISE

file name: 320678-01C0300.dwg, layout name: C0300, plotted by: Michael Bensch, file location: C:\Users\michael.bensch\AppData\Local\Temp\320678-01C0300.dwg, plot date: 23/02/2024, 3:58 PM, Sheet 2 of 11, Sheets

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AMORY AT RIPLEY

STAGE 01

ROADWORKS STANDARD NOTES AND DETAILS



 IPSWICH CITY COUNCIL

 RIPLEY ROAD DEVELOPMENT PTY LTD

PRELIMINARY

 Drg No **320678-01C0300**

 Rev **B**

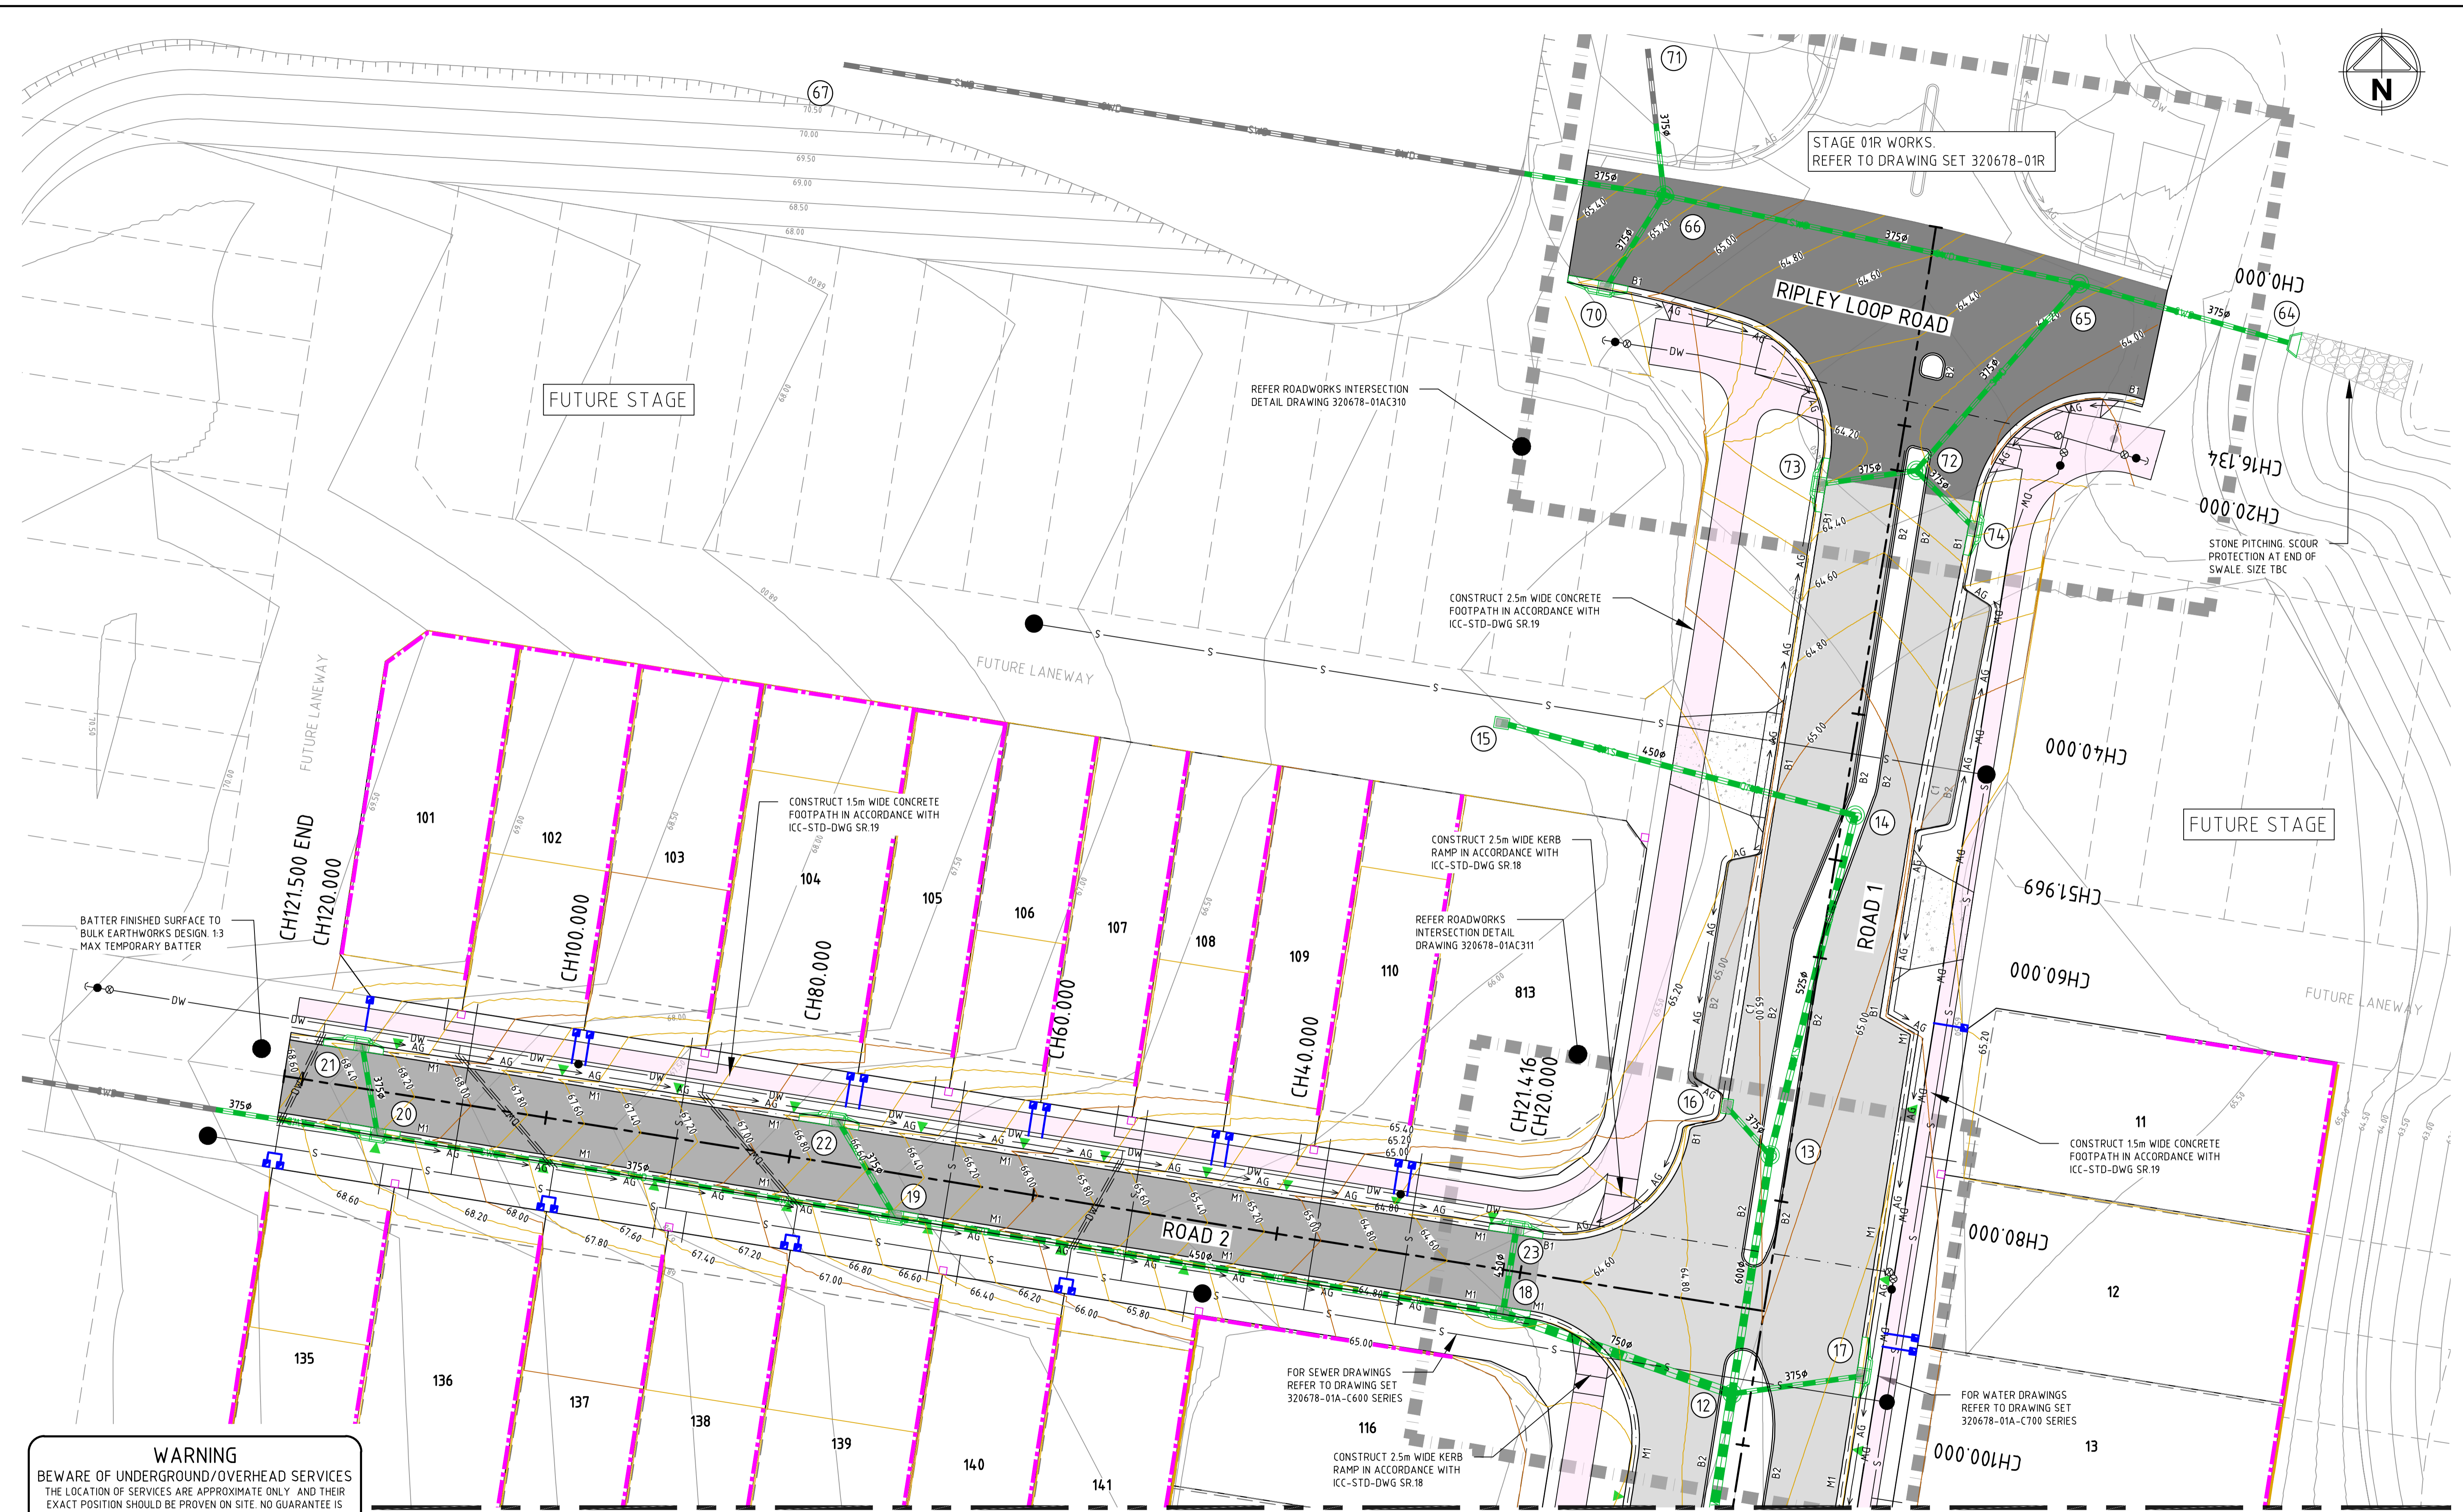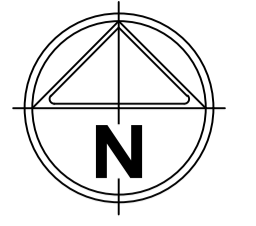

WARNING
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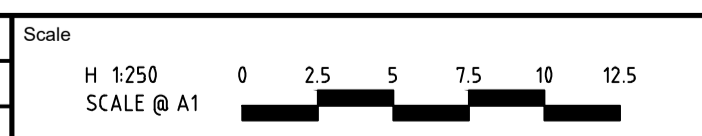
ROADWORKS & DRAINAGE LAYOUT PLAN - SHEET 1 OF 2

SCALE 1:250

FOR CONTINUATION REFER TO DRG 320678-01C0302

file name: 320678-01C0301.dwg; layout name: C3201; plot by: Michael Bannister; plot date: 23/02/2024; 3:59 PM; Sheet 6 of 7 Sheets

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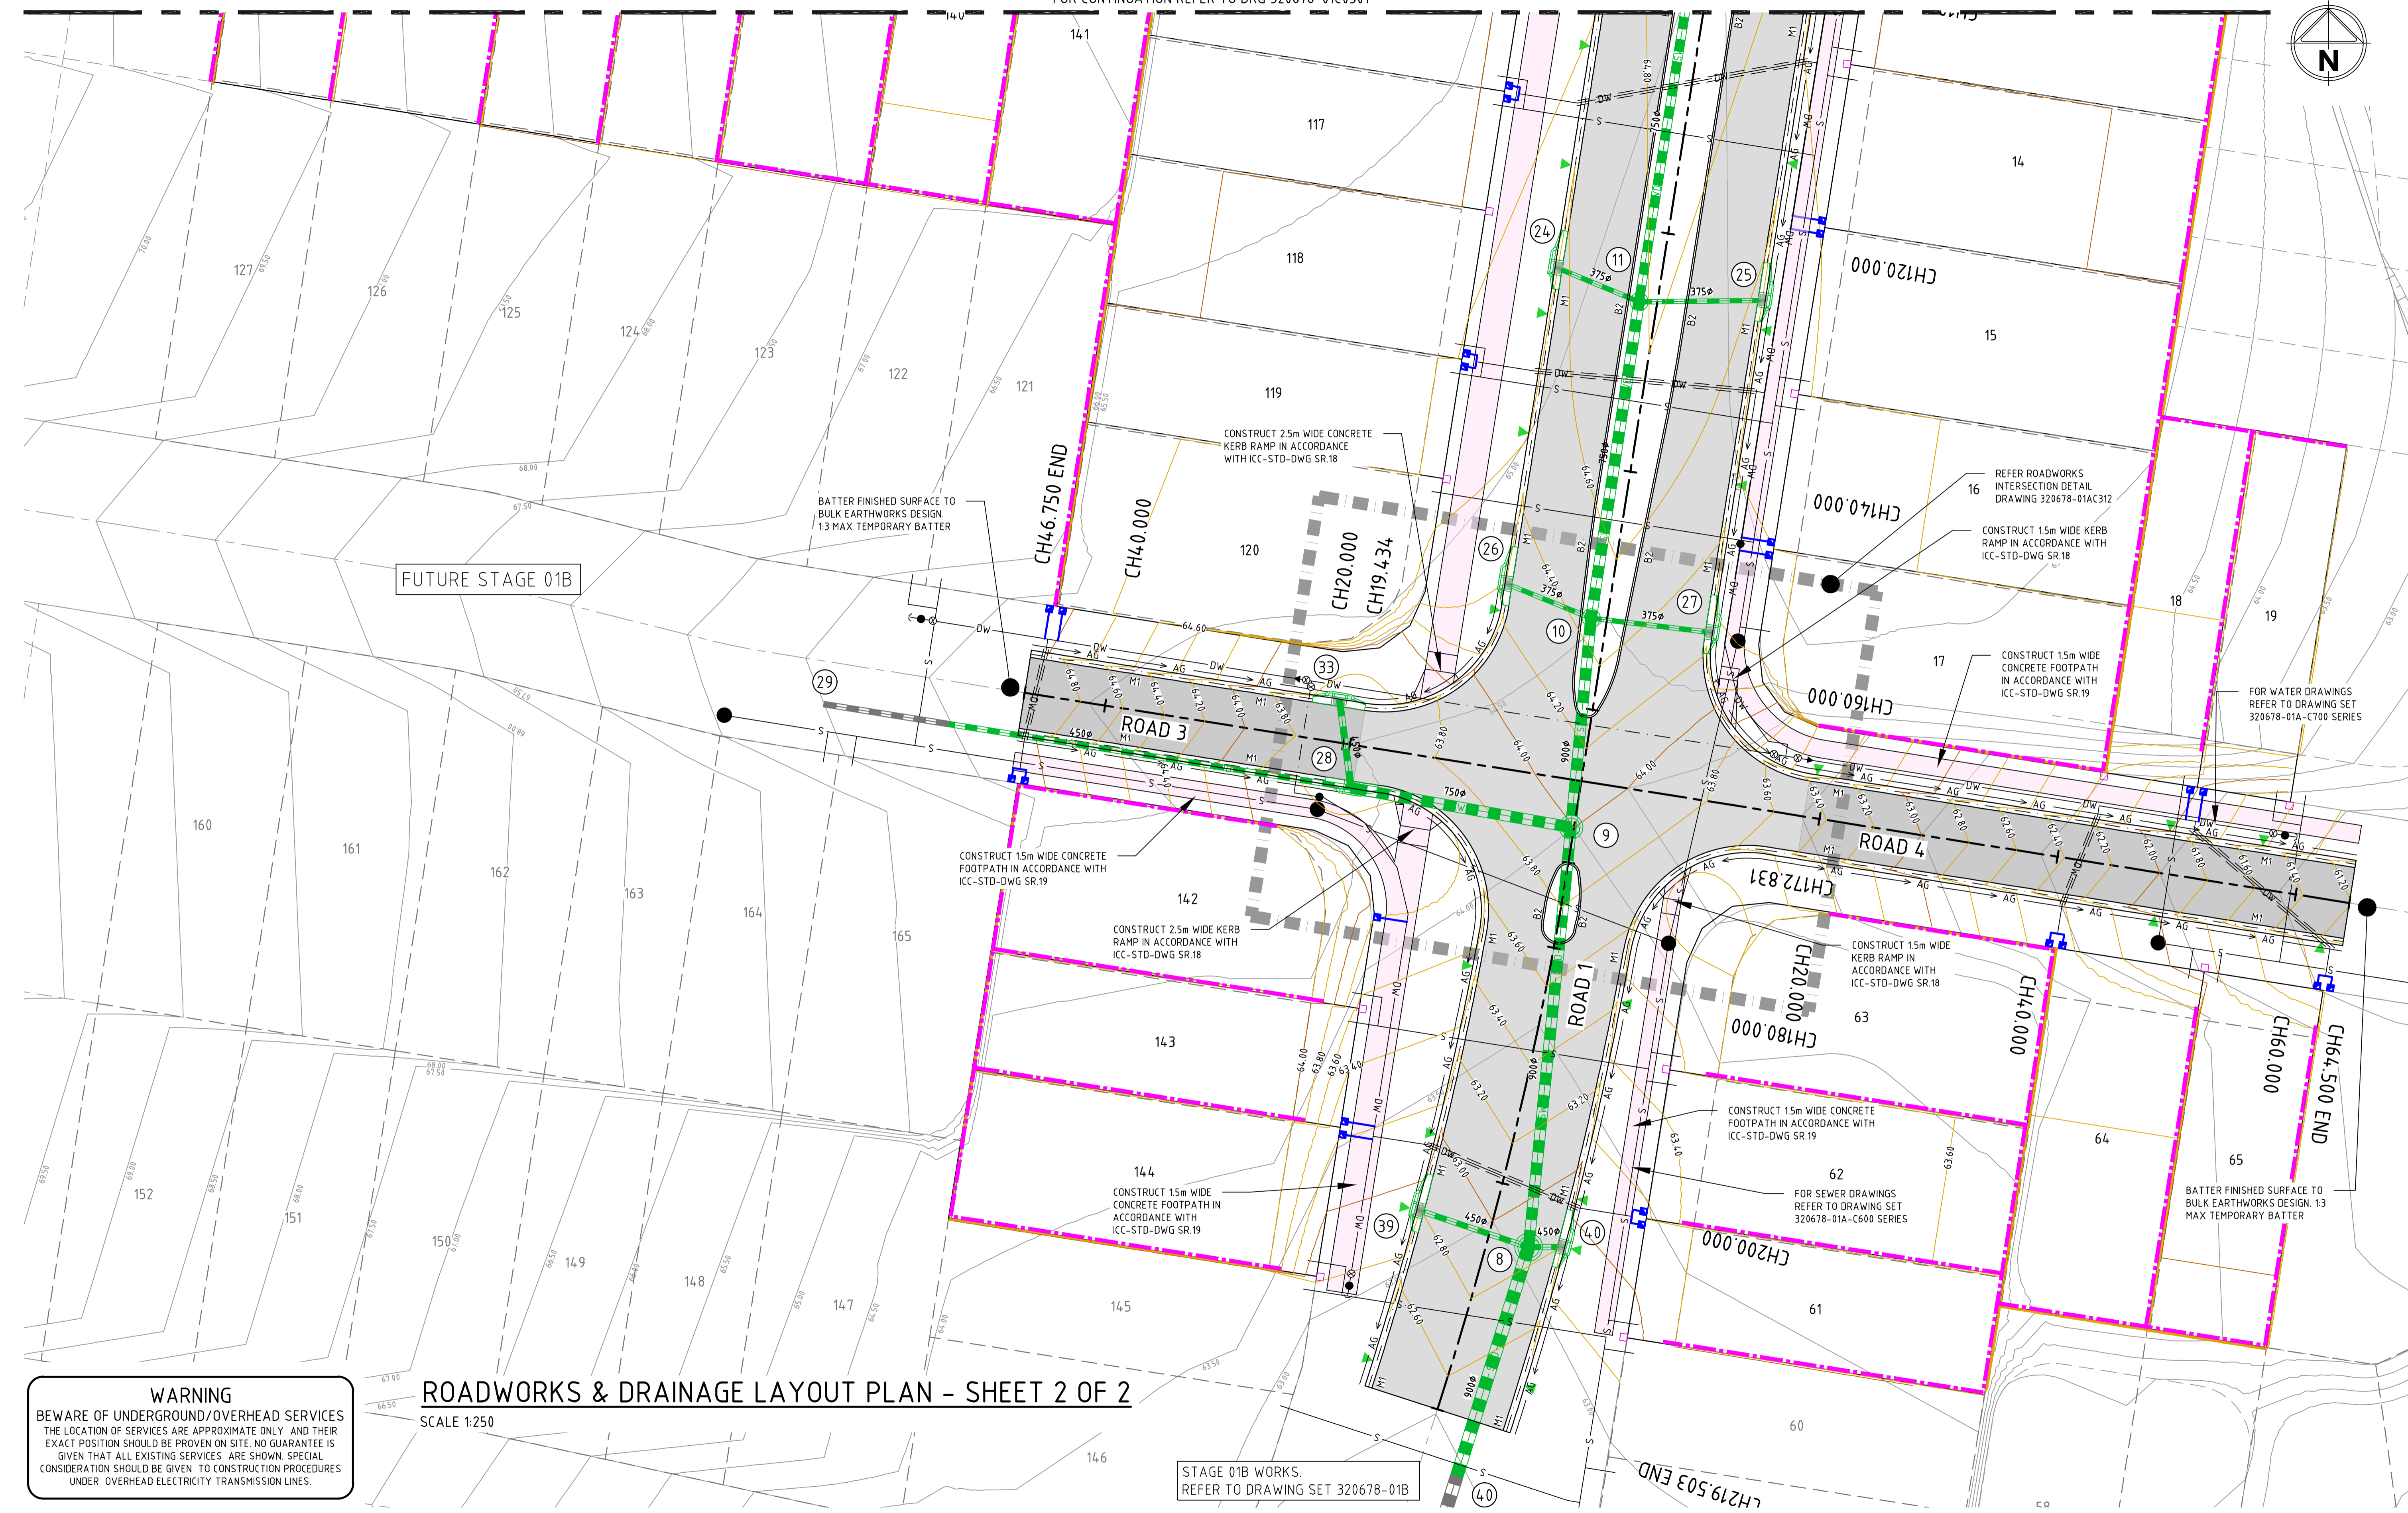
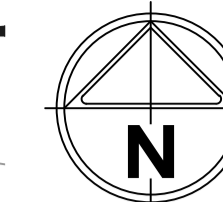


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AMORY AT RIPLEY
STAGE 01
ROADWORKS & DRAINAGE LAYOUT PLAN
SHEET 1 OF 2
 IPSWICH CITY COUNCIL
 RIPLEY ROAD DEVELOPMENT PTY LTD
PRELIMINARY Drg No 320678-01C0301 Rev B





ROADWORKS & DRAINAGE LAYOUT PLAN - SHEET 2 OF 2

SCALE 1:250

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STAGE 01B WORKS.
REFER TO DRAWING SET 320678-01B

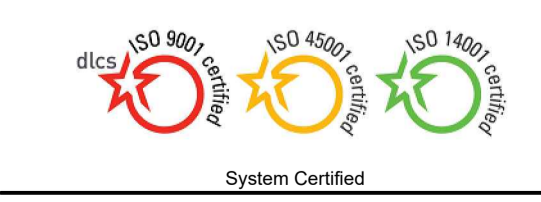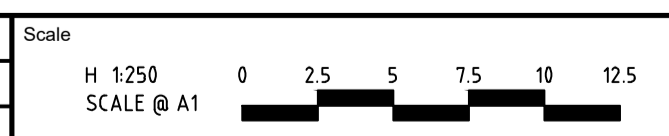

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AMORY AT RIPLEY
STAGE 01
ROADWORKS & DRAINAGE LAYOUT PLAN
SHEET 2 OF 2
IPSWICH CITY COUNCIL
RIPLEY ROAD DEVELOPMENT PTY LTD
PRELIMINARY Drg No 320678-01C0302 Rev B

file name: 320678-01C0302.dwg, layout name: C302, plotted by: Michael Bremer, file location: C:\Users\m.bremer\OneDrive\Documents\320678-01C0302.dwg, 3:59 PM, Sheet 7 of 7 Sheets

file name: 320678-01C0303.dwg, layout name: C0303, plotted by: Michael Benschner, file location: C:\Users\michael.benschner\OneDrive - Spiire Australia Pty Ltd\Documents\320678-01C0303.dwg, plot date: 23/02/2024, 3:59 PM, Sheet 5 of 9 Sheets



Vertical Curve Length (m)
Vertical Curve Radius (m)
Vertical Grade (%)
Vertical Grade (1 in ...)

DATUM RL55.000

DESIGN LEVELS LEFT LIP OF KERB	REFER TO DRAWING 320678-01C0310 FOR INTERSECTION LEVELS		64.127	64.229	64.335	64.879	64.886	65.017	65.010	64.984	REFER TO DRAWING 320678-01C0311 FOR INTERSECTION LEVELS		64.603	64.549	64.469
DESIGN LEVELS RIGHT LIP OF KERB				64.201	64.310	64.869	64.876	65.017	65.010	64.984	64.803		64.603	64.549	64.469
CUT / FILL DEPTH	1.518	1.323	1.284	1.296	1.354	1.467	1.583	2.094	2.099	2.102	2.058	1.263	0.315	64.703	-1.985
DESIGN LEVELS ON ROAD CL	64.672	64.295	64.239	64.245	64.293	64.395	64.502	65.045	65.052	65.177	65.150	65.050	64.950	64.850	64.715
EXISTING SURFACE ON ROAD CL	63.154	62.972	62.954	62.949	62.939	62.928	62.919	62.951	62.953	63.082	63.118	63.230	64.635	65.750	66.700
CHAINAGE	0.000	12.567	16.317	17.567	20.000	22.567	24.697	39.697	40.000	51.969	54.697	60.000	80.000	100.000	120.000

LONGITUDINAL SECTION - ROAD 1

SCALE HORIZONTAL 1 : 250
VERTICAL 1 : 100

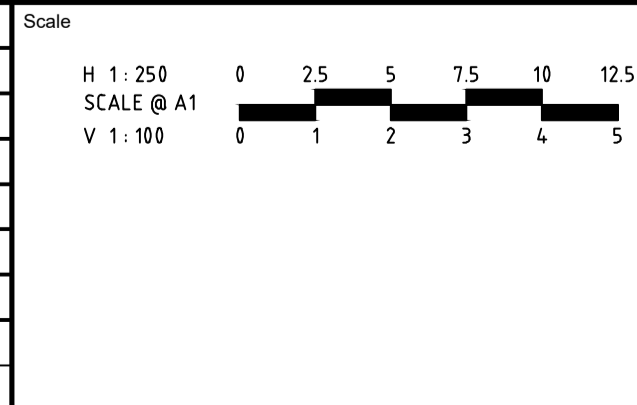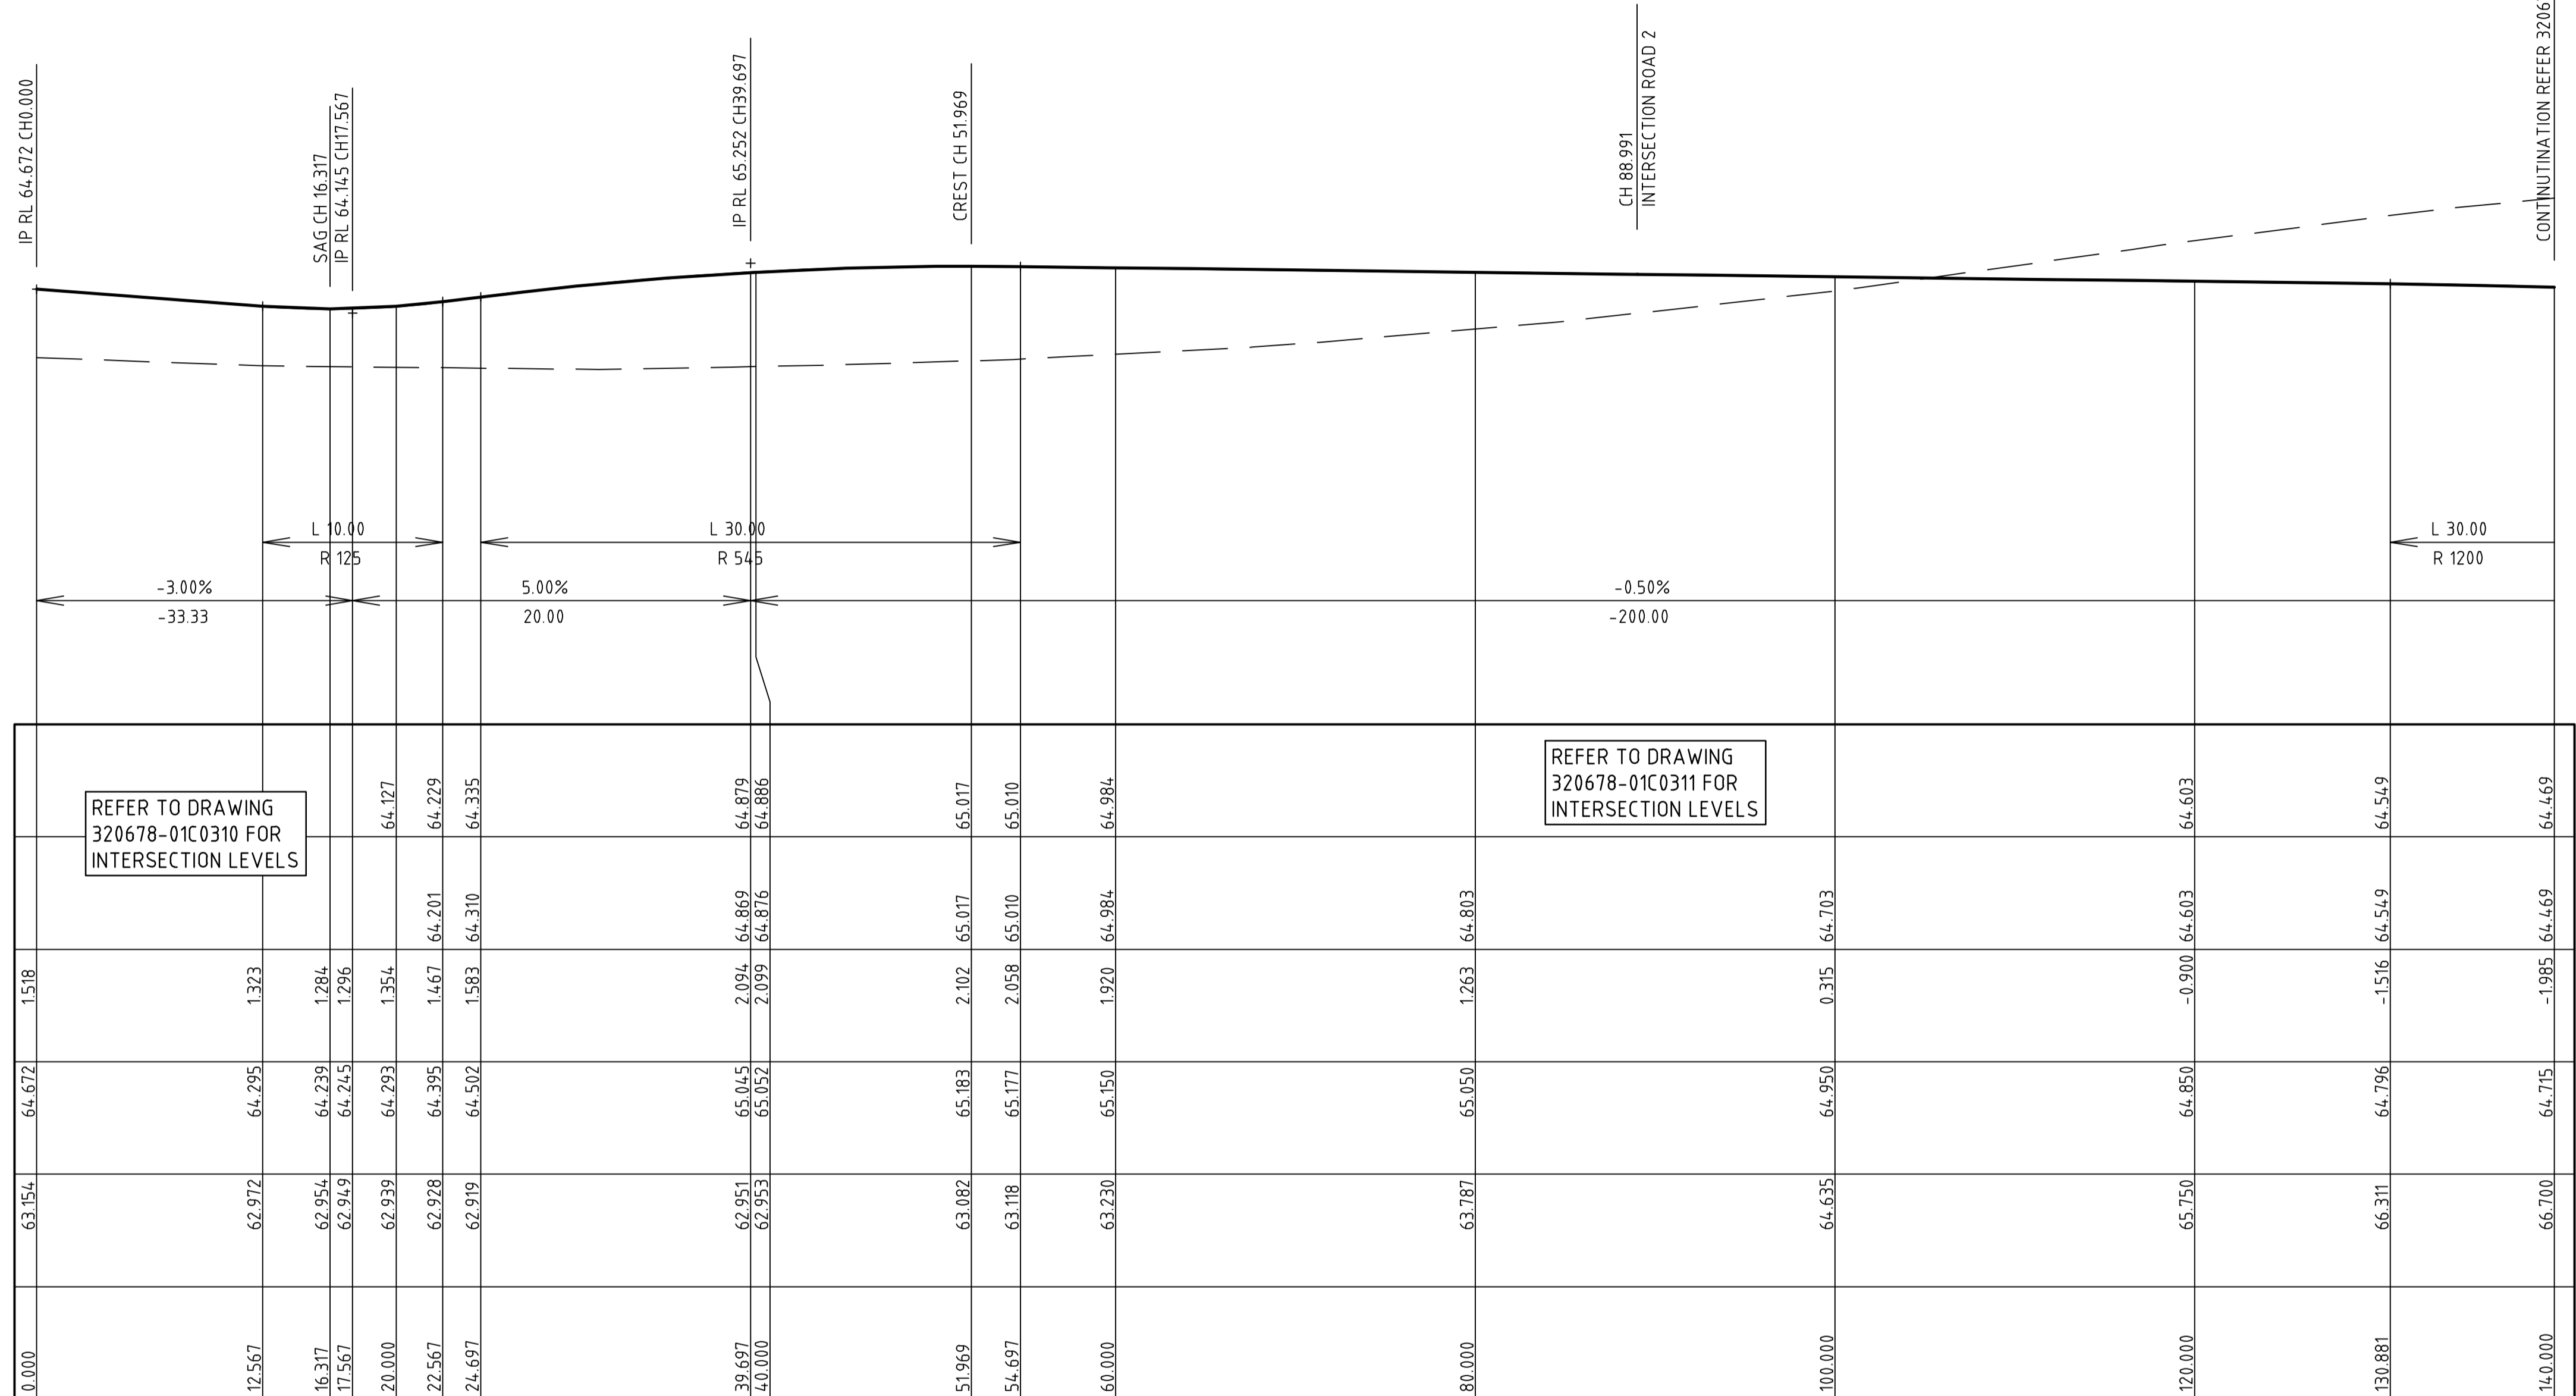

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AMORY AT RIPLEY

STAGE 01

ROAD 1 LONGITUDINAL SECTION

SHEET 1 OF 2

 IPSWICH CITY COUNCIL

 RIPLEY ROAD DEVELOPMENT PTY LTD

PRELIMINARY

 Drg No 320678-01C0303 Rev B

CONTINUATION REFER 320678-01AC0303

IP RL 64.721 CH145.881

CH 165.991
INTERSECTION ROAD 3 & 4

Vertical Curve Length (m)
Vertical Curve Radius (m)
Vertical Grade (%)
Vertical Grade (1 in ...)

DATUM RL55.000

DESIGN LEVELS LEFT LIP OF KERB	64.603	64.549	64.469	64.380		63.525	62.925	62.340
DESIGN LEVELS RIGHT LIP OF KERB	64.603	64.549	64.469	64.380		63.525	62.925	62.340
CUT / FILL DEPTH	-0.900	-1.516	-1.985	-2.305	-2.773	-2.800	-2.569	-1.747
DESIGN LEVELS ON ROAD CL	64.850	64.796	64.715	64.627	64.297	63.972	63.697	63.097
EXISTING SURFACE ON ROAD CL	65.750	66.311	66.700	66.932	67.070	66.621	66.266	65.090
CHAINAGE	120.000	130.881	140.000	145.881	160.000	160.881	172.831	180.000

LONGITUDINAL SECTION - ROAD 1


SCALE HORIZONTAL 1: 250
VERTICAL 1: 100

REFER TO DRAWING
320678-01C0312 & C0313
FOR INTERSECTION LEVELS

CONTROL LINE - ROAD 1 - HORIZONTAL POINTS								
PT	CHAINAGE	EASTING	NORTHING	HEIGHT	BEARING	RAD/SPIRAL	A.LENGTH	DEFL.ANGLE
IP 1	0.000	9979.420	37281.728	64.672	189°00'50.01"			
	10.000	9977.853	37271.852	64.372	189°00'50.01"			
	20.000	9976.287	37261.975	64.293	189°00'50.01"			
	30.000	9974.720	37252.099	64.741	189°00'50.01"			
	40.000	9973.153	37242.222	65.052	189°00'50.01"			
	50.000	9971.586	37232.346	65.180	189°00'50.01"			
	60.000	9970.020	37222.469	65.150	189°00'50.01"			
	70.000	9968.453	37212.593	65.100	189°00'50.01"			
	80.000	9966.886	37202.716	65.050	189°00'50.01"			
	90.000	9965.319	37192.840	65.000	189°00'50.01"			
	100.000	9963.753	37182.963	64.950	189°00'50.01"			
	110.000	9962.186	37173.087	64.900	189°00'50.01"			
	120.000	9960.619	37163.210	64.850	189°00'50.01"			
	130.000	9959.052	37153.334	64.800	189°00'50.01"			
	140.000	9957.486	37143.457	64.715	189°00'50.01"			
	150.000	9955.919	37133.581	64.548	189°00'50.01"			
	160.000	9954.352	37123.704	64.297	189°00'50.01"			
	170.000	9952.786	37113.828	63.997	189°00'50.01"			
TC	172.831	9952.342	37111.031	63.912	189°00'50.01"			
	180.000	9951.134	37103.965	63.697	190°22'58.82"			
	190.000	9949.168	37094.161	63.397	192°17'34.31"			
IP 2	196.167	9948.678	37087.937	63.212		R = 300.000	4.6672	8°54'49.22"
	200.000	9946.877	37084.428	63.097	194°12'09.80"			
	210.000	9944.262	37074.776	62.797	196°06'45.30"			
CT	219.503	9941.481	37065.689	62.512	197°55'39.23"			
	220.000	9941.328	37065.217	62.497	197°55'39.23"			

file name: 320678-01C0303.dwg, layout name: C0303, plotted by: Michael B...
file location: C:\Users\spire\Documents\320678-01C0303.dwg

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AMORY
AT RIPLEY
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AMORY AT RIPLEY
STAGE 01
ROAD 1 LONGITUDINAL SECTION
SHEET 2 OF 2
IPSWICH CITY COUNCIL
RIPLEY ROAD DEVELOPMENT PTY LTD
PRELIMINARY 320678-01C0304 **B**

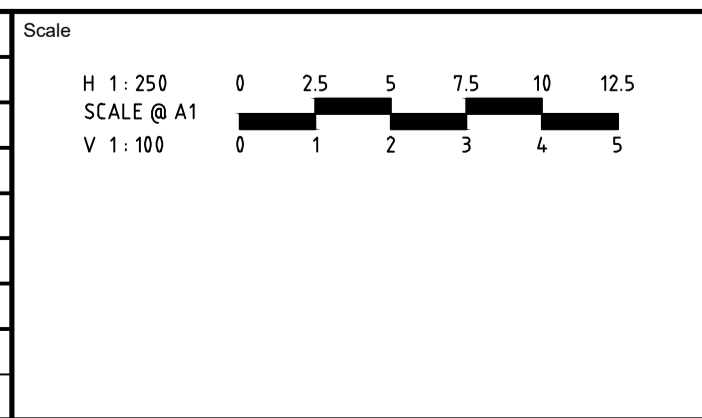Vertical Curve Length (m)
Vertical Curve Radius (m)
Vertical Grade (%)
Vertical Grade (1 in ...)

DATUM RL57.000

DESIGN LEVELS LEFT LIP OF KERB	DESIGN LEVELS RIGHT LIP OF KERB	CUT / FILL DEPTH	DESIGN LEVELS ON ROAD CL	EXISTING SURFACE ON ROAD CL	CHAINAGE
REFER TO DRAWING 320678-01C0311 FOR INTERSECTION LEVELS					
		0.865	65.005	64.140	0.000
		0.062	64.734	64.672	9.047
		-0.355	64.615	64.970	14.047
		-0.726	64.559	65.285	19.047
		-0.795	64.554	65.350	20.000
		-0.823	64.552	65.375	20.375
		-0.897	64.550	65.447	21.416
		-1.136	64.587	65.723	25.375
		-1.330	64.742	66.072	30.375
		-1.721	65.156	66.877	40.000
		-2.512	66.016	68.528	60.000
		-2.968	66.787	69.844	80.000
		-3.914	67.647	71.650	100.000
		-5.005	68.507	73.601	120.000
		-5.093	68.660	73.753	121.500

LONGITUDINAL SECTION - ROAD 2



SCALE HORIZONTAL 1 : 250
VERTICAL 1 : 100

CONTROL LINE - ROAD 2 - HORIZONTAL POINTS

PT	CHAINAGE	EASTING	NORTHING	HEIGHT	BEARING
IP 1	0.000	9965.481	37193.836	65.005	279°00'49.57"
	10.000	9955.605	37195.403	64.706	279°00'49.57"
	20.000	9945.728	37196.969	64.554	279°00'49.57"
	30.000	9935.852	37198.536	64.726	279°00'49.57"
	40.000	9925.975	37200.103	65.156	279°00'49.57"
	50.000	9916.099	37201.669	65.586	279°00'49.57"
	60.000	9906.222	37203.236	66.016	279°00'49.57"
	70.000	9896.346	37204.803	66.446	279°00'49.57"
	80.000	9886.469	37206.370	66.876	279°00'49.57"
	90.000	9876.593	37207.936	67.306	279°00'49.57"
	100.000	9866.716	37209.503	67.736	279°00'49.57"
	110.000	9856.840	37211.070	68.166	279°00'49.57"
	120.000	9846.963	37212.637	68.596	279°00'49.57"

file name: 320678-01C0306.dwg; layout name: C0306; plotted by: Michael Bensch; file location: C:\Users\spire\OneDrive\Documents\320678-01C0306.dwg; plot date: 23/02/2024, 3:59 PM; Sheet 5 of 9 Sheets

Rev	Amendments	Approved	Date
B	ISSUE FOR TENDER	K.H.	21-02-24
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AMORY
AT RIPLEY







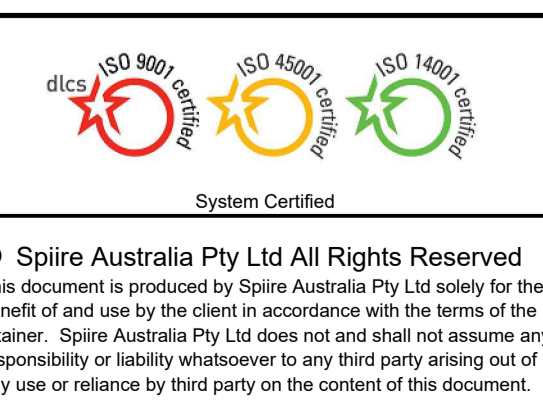
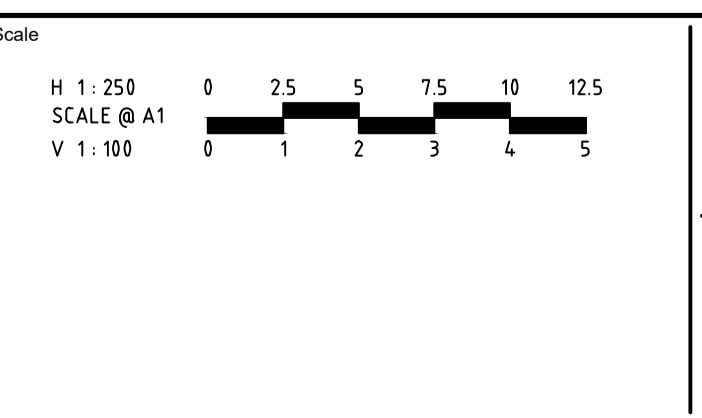
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AMORY AT RIPLEY
STAGE 01
ROAD 2 LONGITUDINAL SECTION

IPSWICH CITY COUNCIL
RIPLEY ROAD DEVELOPMENT PTY LTD


PRELIMINARY Drg No 320678-01C0306 Rev B

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CROSS SECTIONS - ROAD 2 - CH0.000 TO CH121.500
 SCALE HORIZONTAL 1 : 250
 VERTICAL 1 : 100

Rev	Amendments	Approved	Date
B	ISSUE FOR TENDER	K.H.	21-02-24
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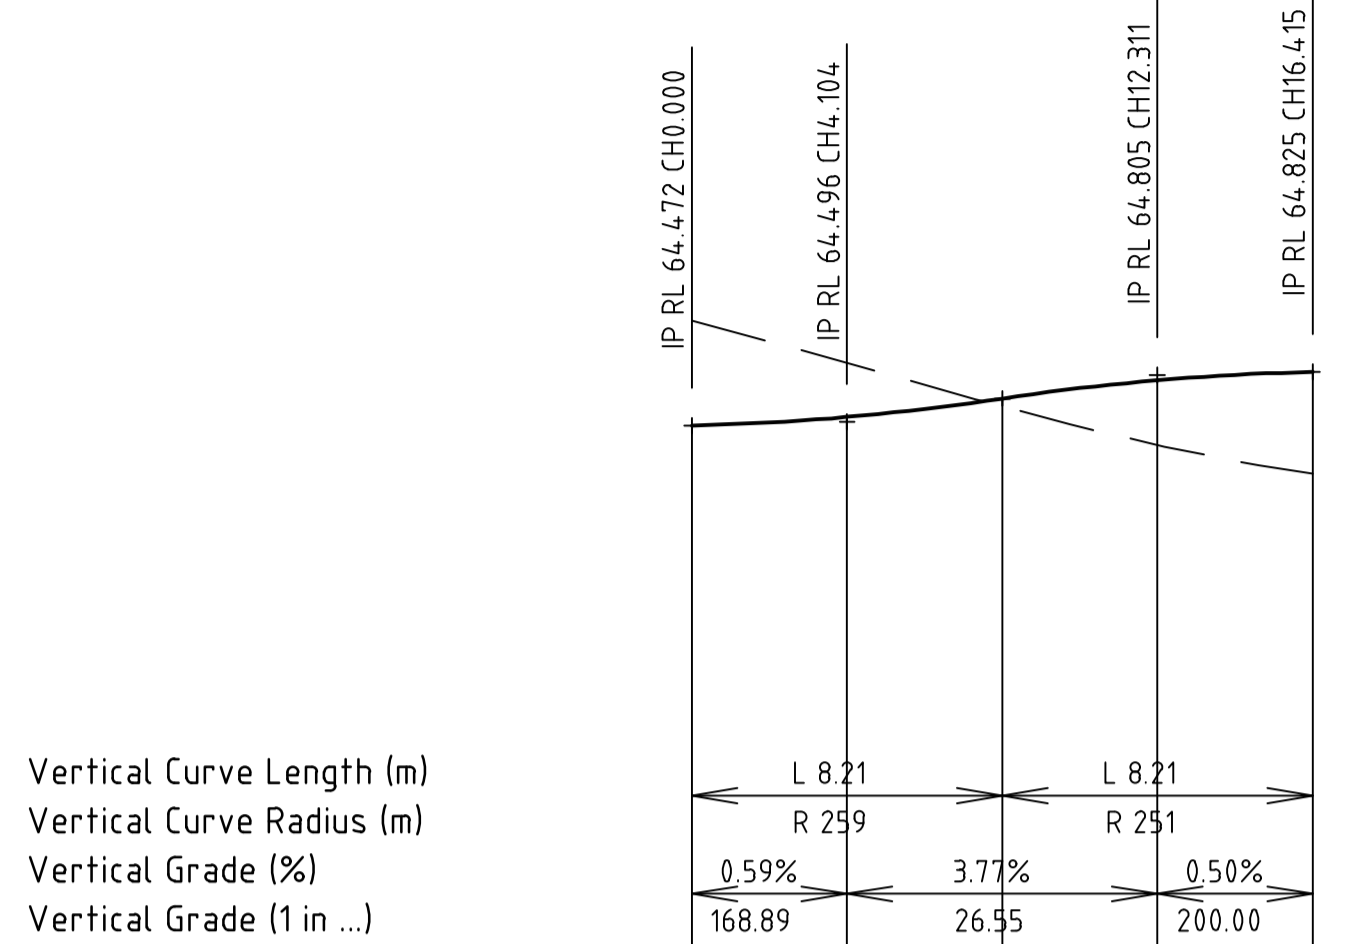
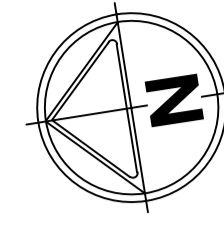
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AMORY AT RIPLEY
 STAGE 01
 ROAD 2 CROSS SECTIONS

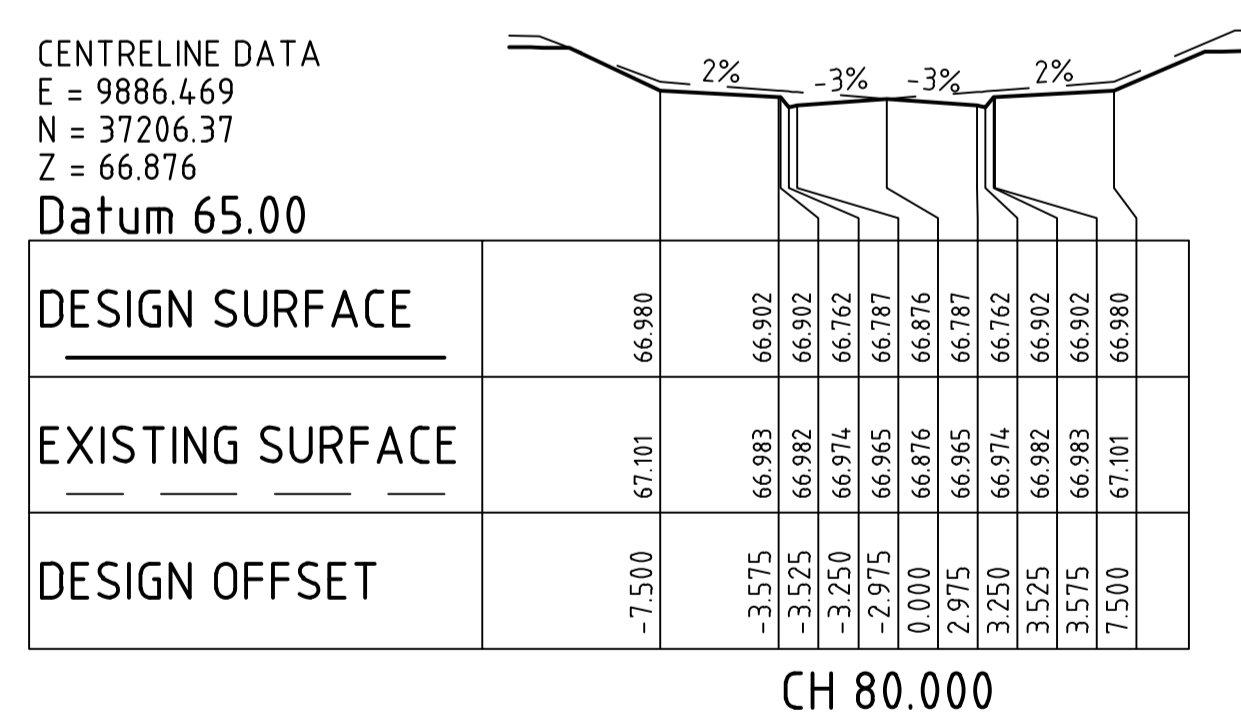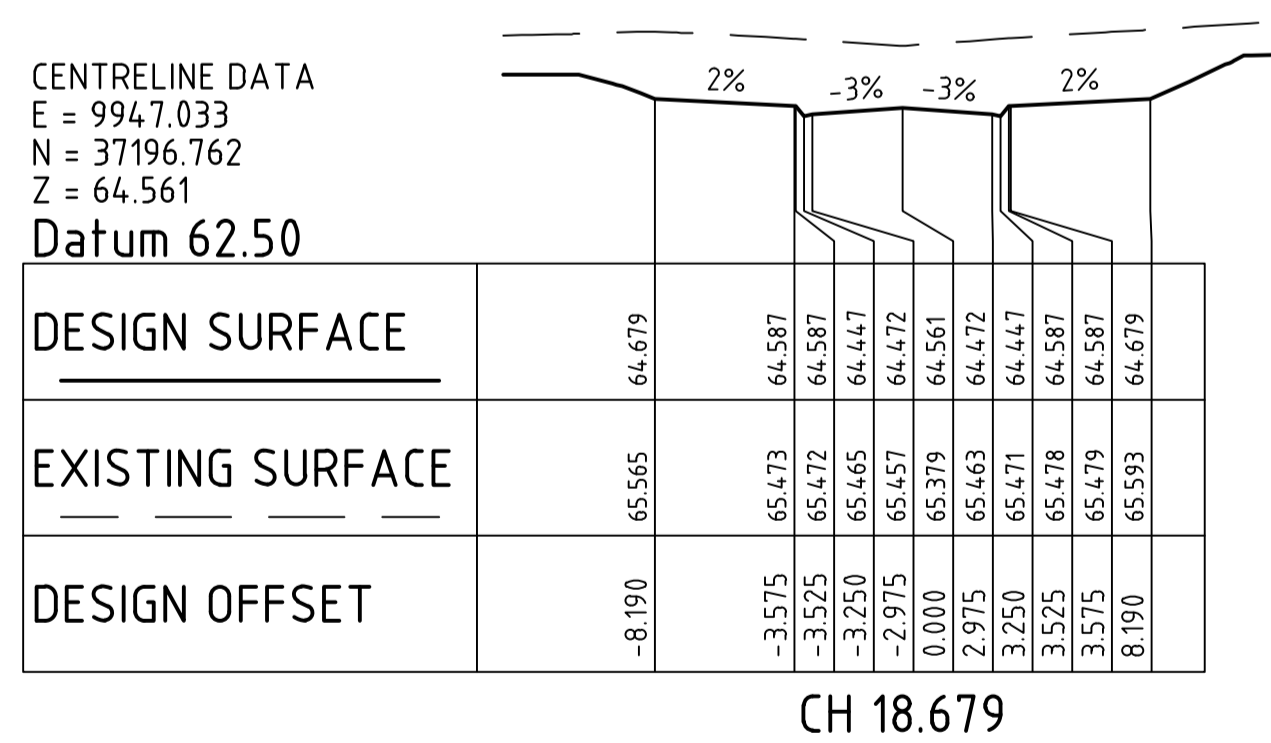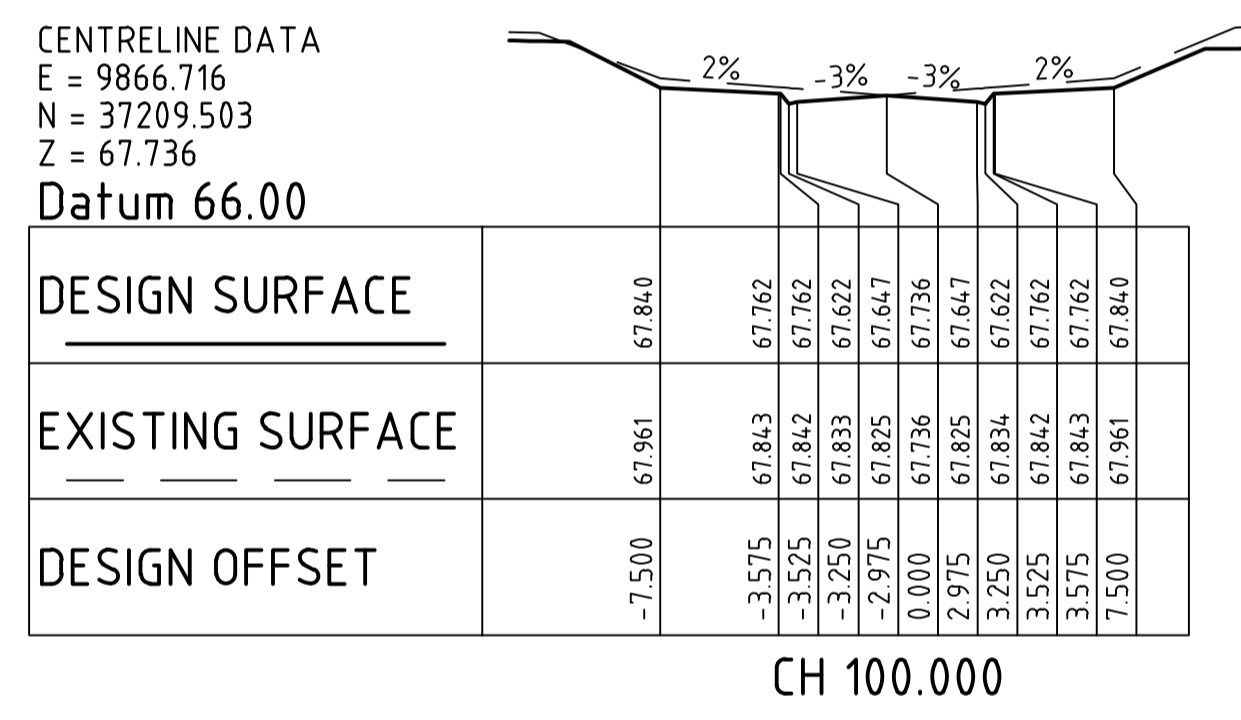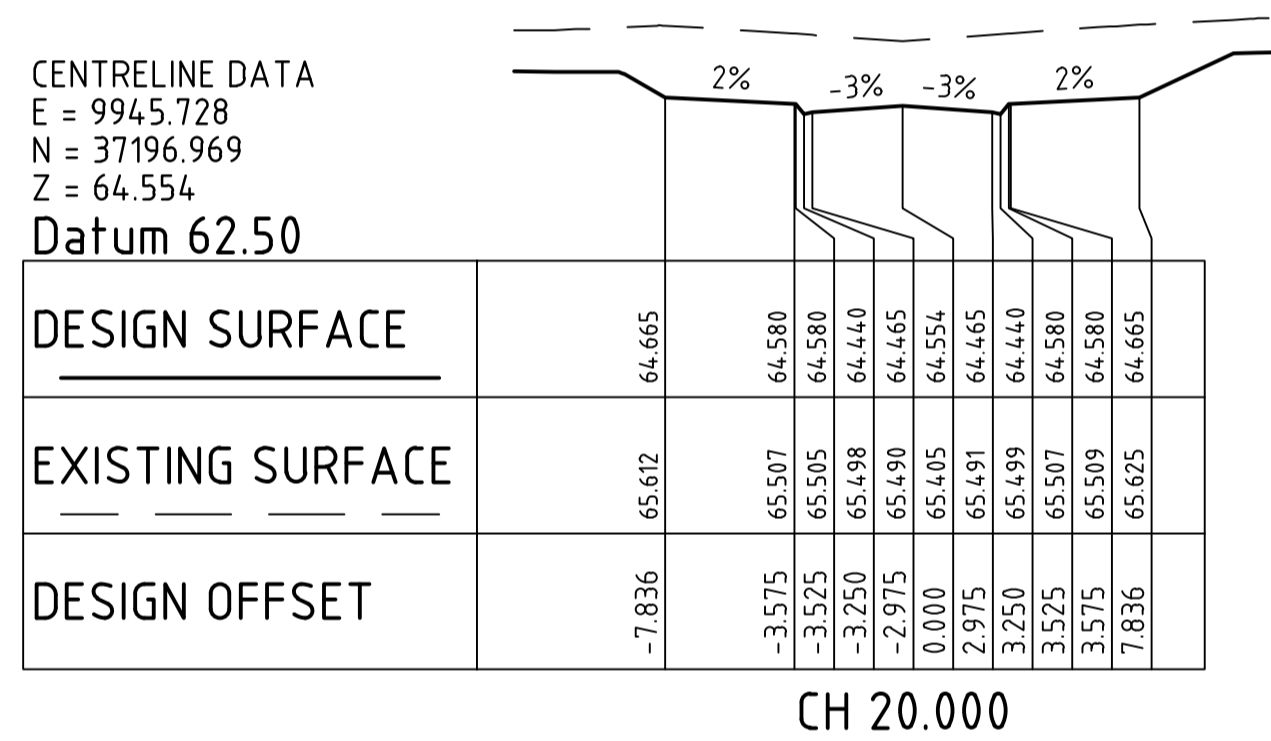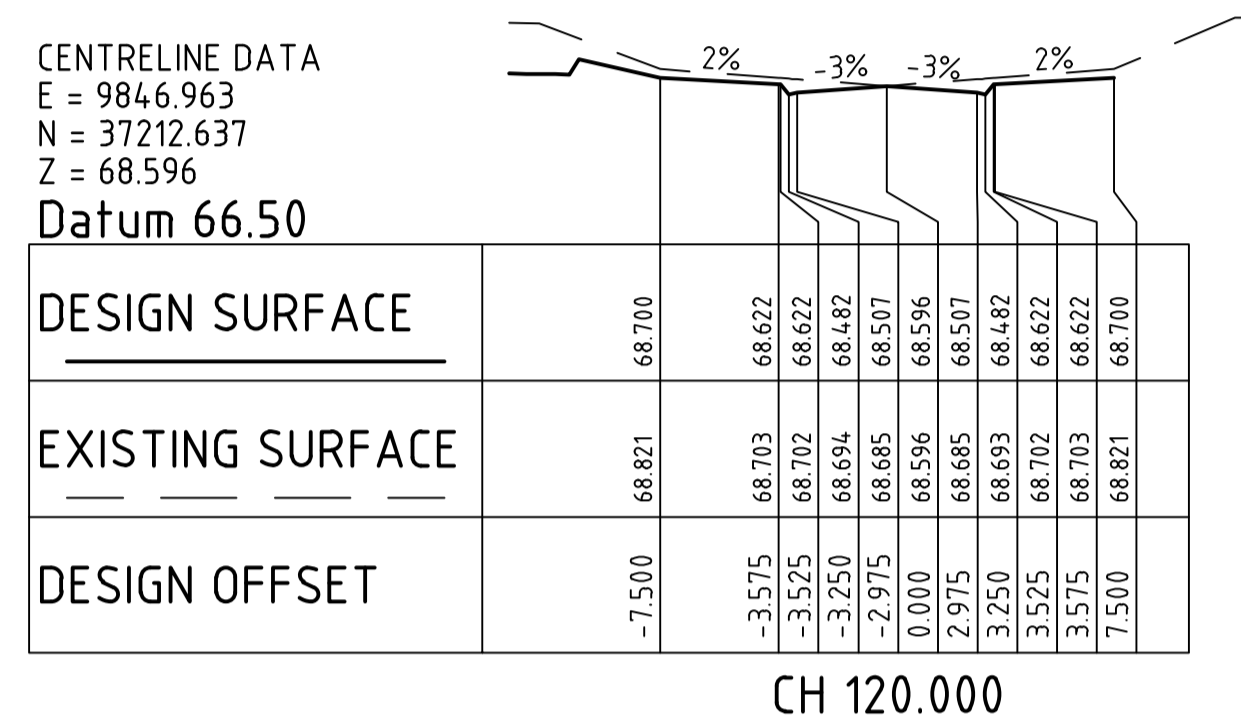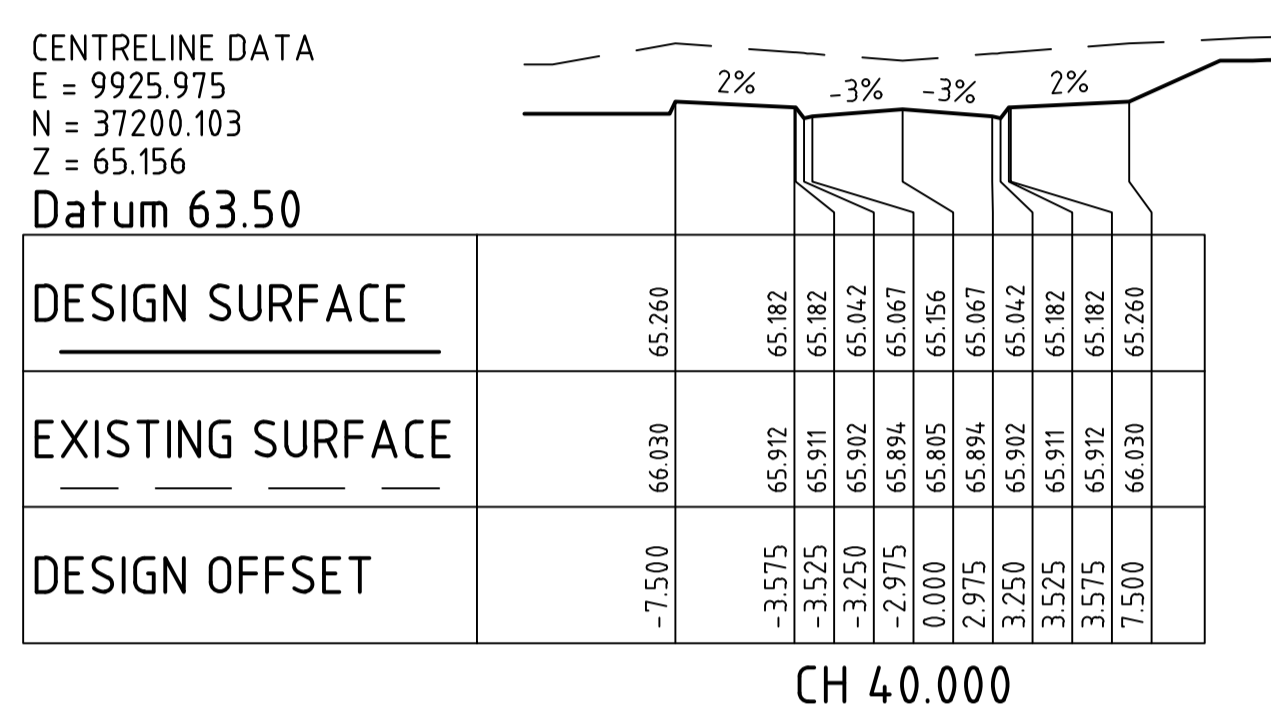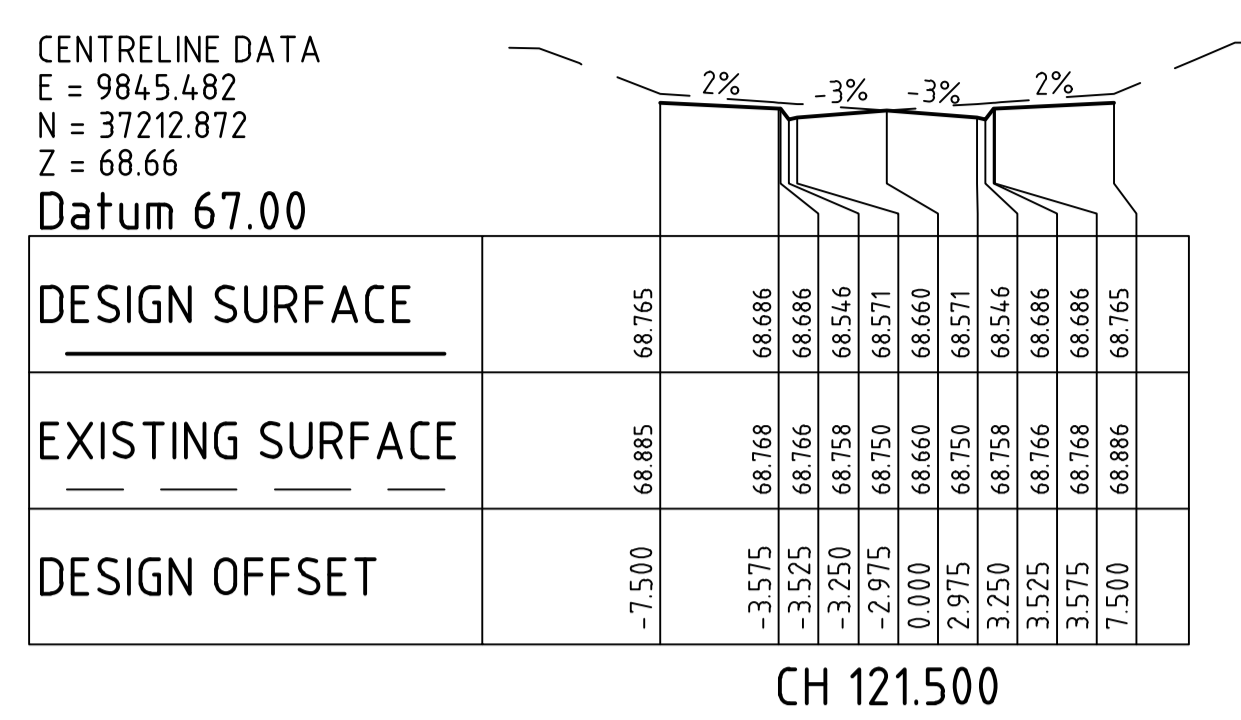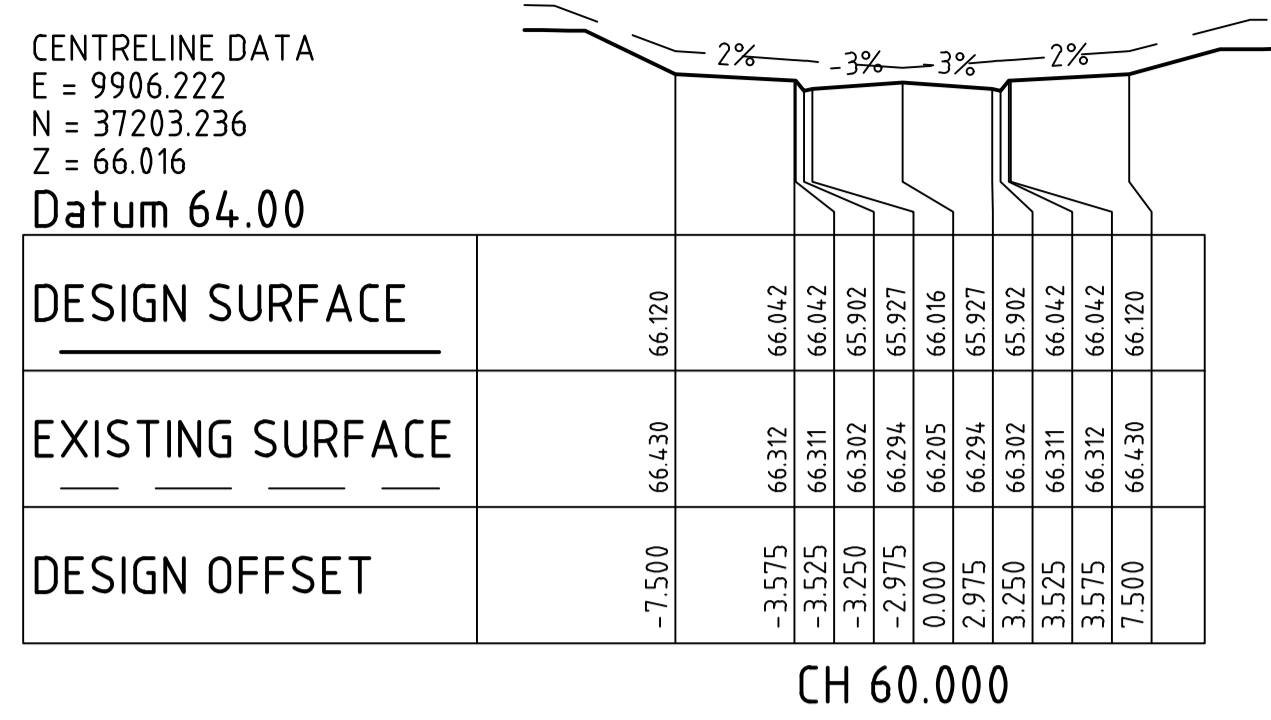IPSWICH CITY COUNCIL
 RIPLEY ROAD DEVELOPMENT PTY LTD

PRELIMINARY 320678-01C0307 **B**

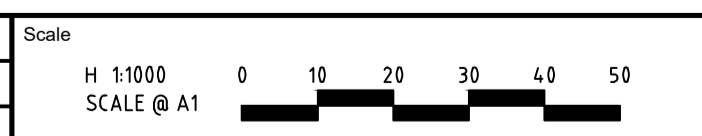


DATUM RL60.000


Vertical Curve Length (m)	Vertical Curve Radius (m)	Vertical Grade (%)	Vertical Grade (1 in ...)
168.89	R 259	0.59%	168.89
200.00	R 251	3.77%	26.55
		0.50%	200.00

CUT / FILL DEPTH	DESIGN LEVELS ON KERB LIP	EXISTING SURFACE ON KERB LIP	CHAINAGE
-0.692	64.472	65.163	0.000
-0.357	64.528	64.885	4.104
0.053	64.650	64.597	8.207
0.430	64.771	64.341	12.311
0.671	64.825	64.155	16.415

LONGITUDINAL SECTION - RD2 RD1
SCALE HORIZONTAL 1:200
VERTICAL 1:50

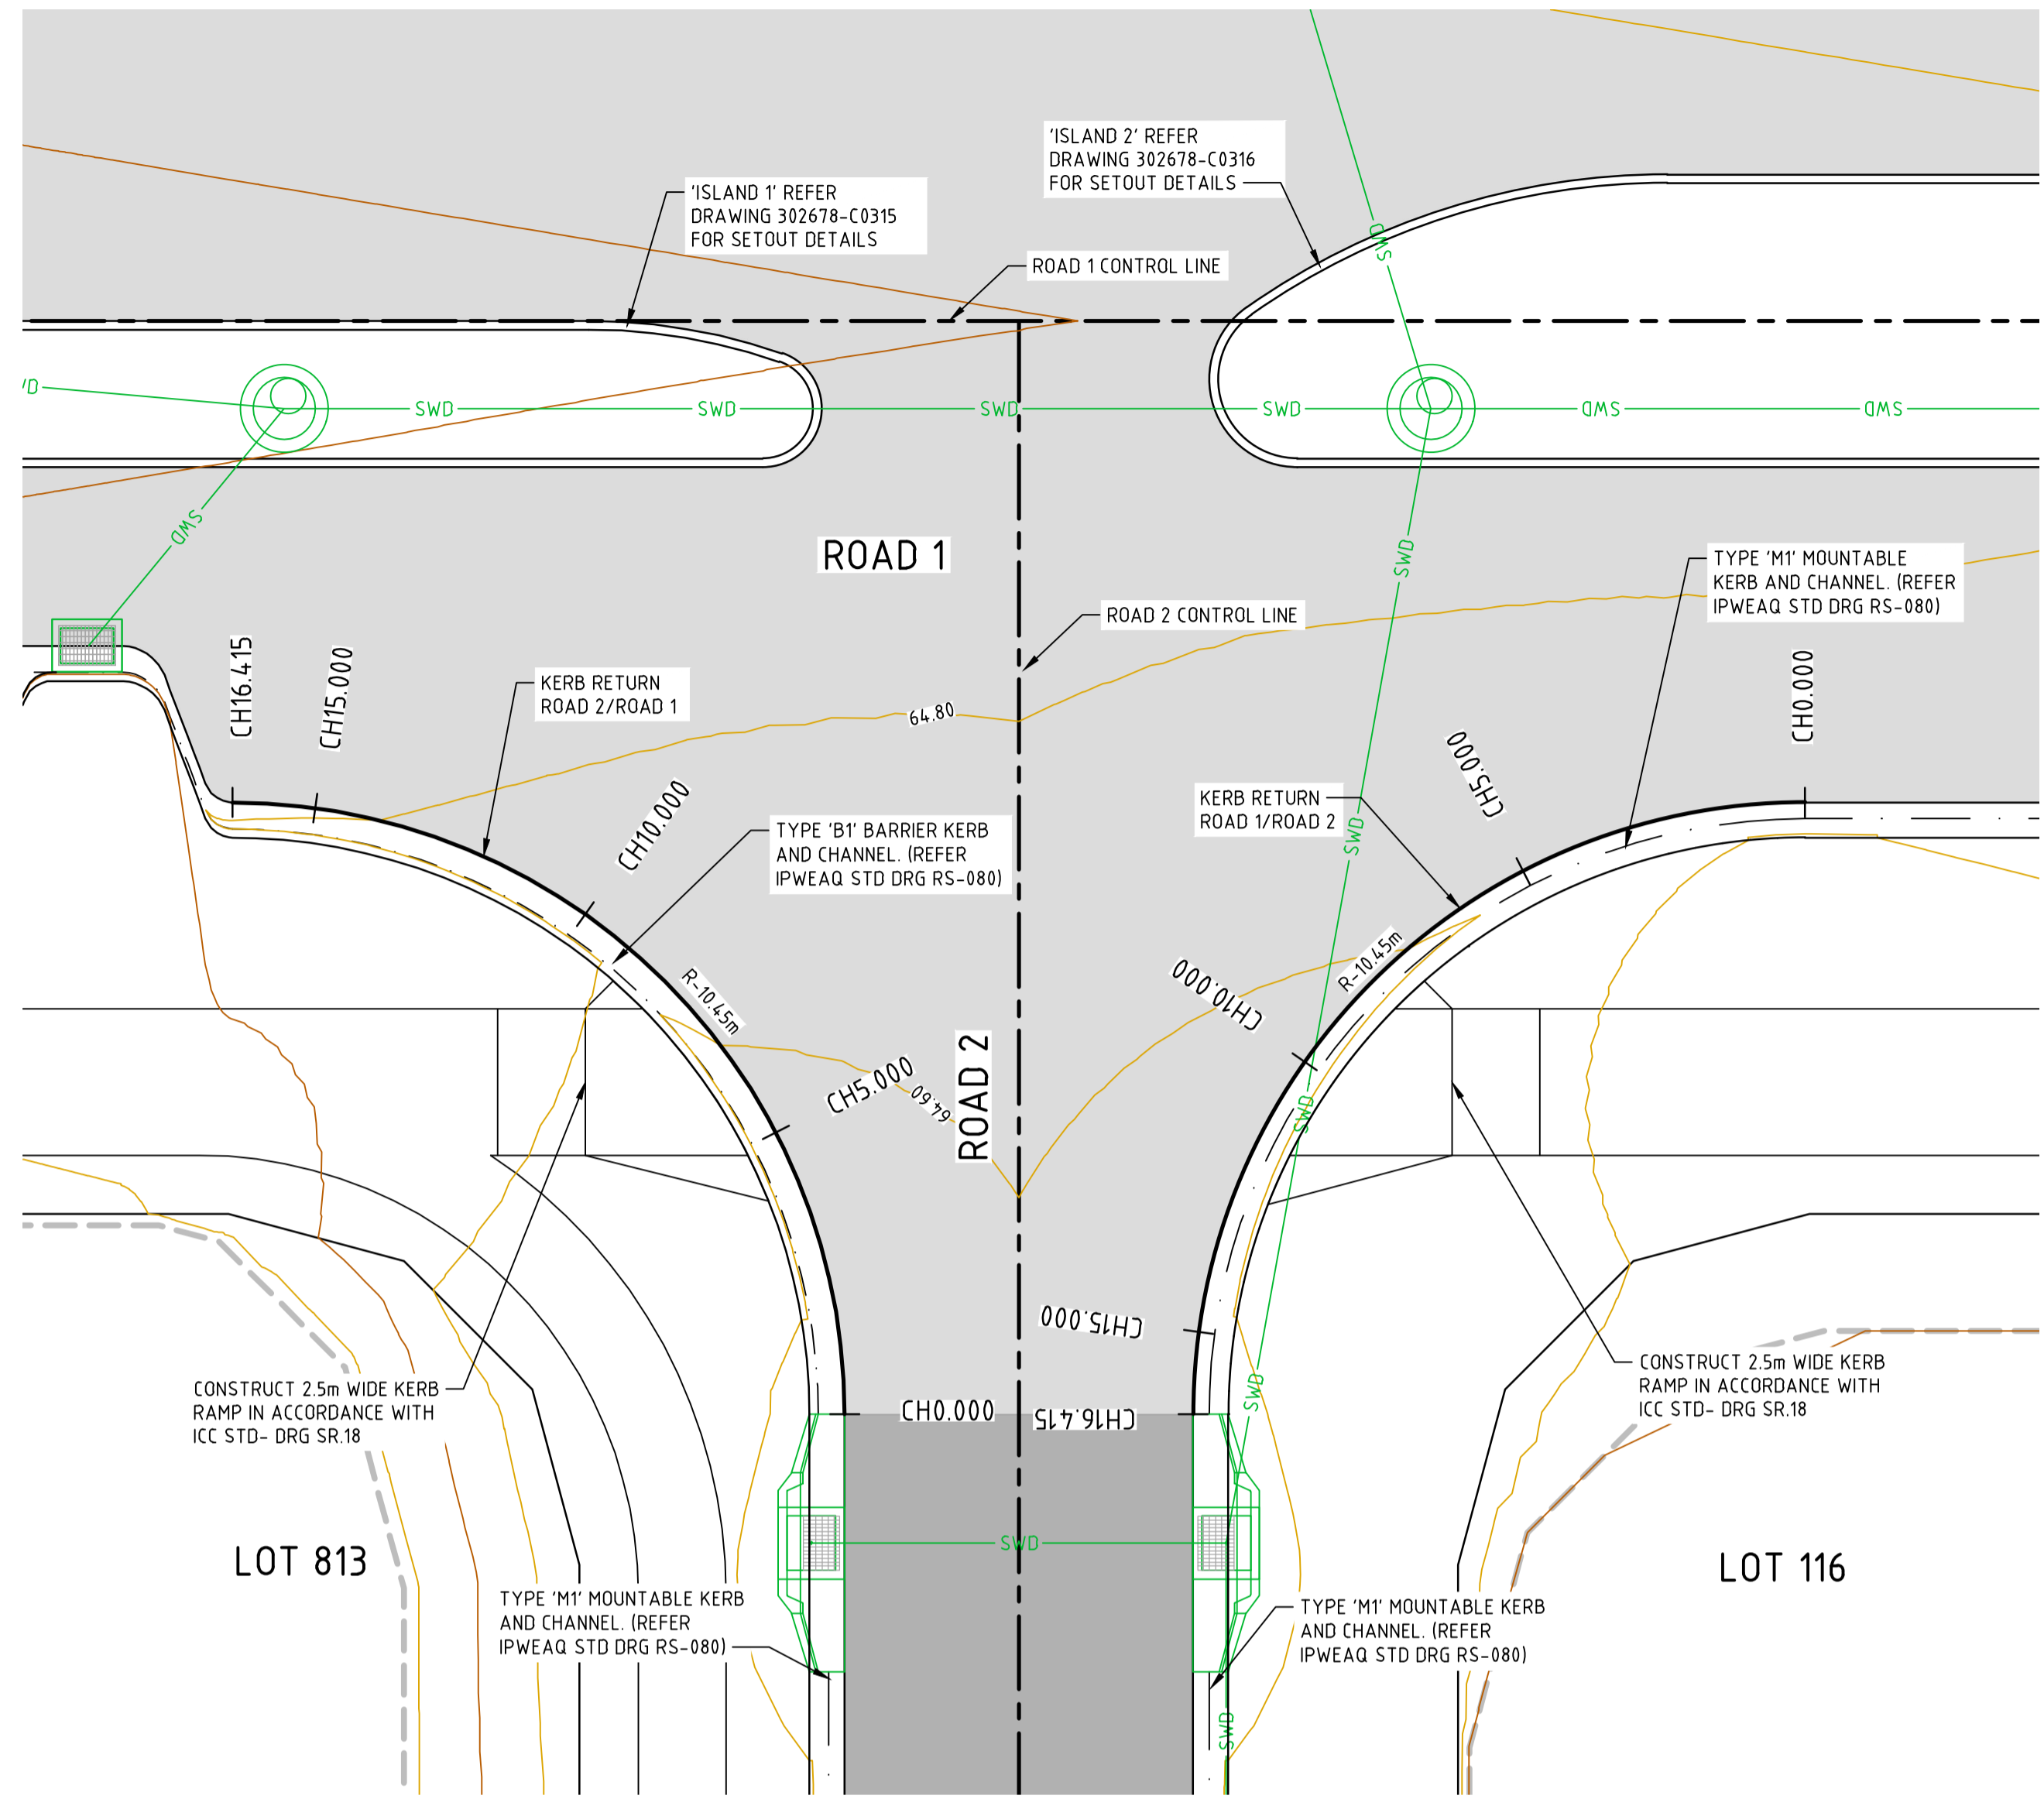

INTERSECTION DETAIL PLAN - ROAD 1/ROAD 2
SCALE 1:100

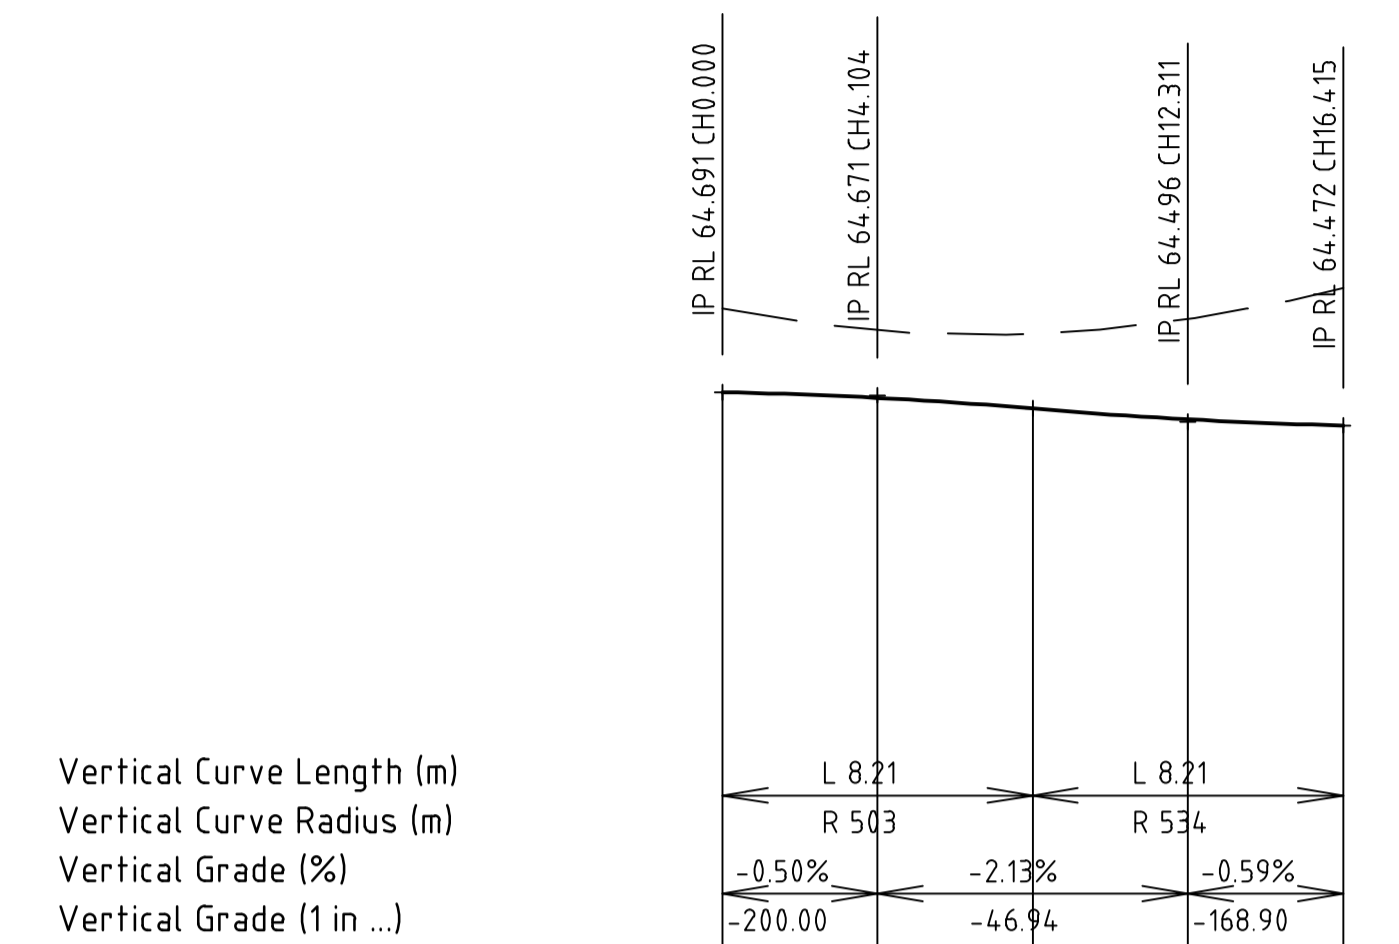

DATUM RL60.000

Vertical Curve Length (m)	Vertical Curve Radius (m)	Vertical Grade (%)	Vertical Grade (1 in ...)
200.00	R 503	-0.50%	-200.00
168.90	R 534	-2.13%	-46.94
		-0.59%	-168.90

CUT / FILL DEPTH	DESIGN LEVELS ON ROAD CL	EXISTING SURFACE ON ROAD CL	CHAINAGE
-0.554	64.691	65.245	0.000
-0.446	64.654	65.100	4.104
-0.492	64.583	65.075	8.207
-0.663	64.512	65.174	12.311
-0.908	64.472	65.379	16.415

LONGITUDINAL SECTION - RD1 RD2
SCALE HORIZONTAL 1:200
VERTICAL 1:50

KERB RETURN - RD2 RD1 HORIZONTAL POINTS

PT	CHAINAGE	EASTING	NORTHING	HEIGHT	BEARING	RAD/SPIRAL	A.LENGTH	DEFL.ANGLE
IP 1	0.000	994.7499	37199.701	64.472	99°00'49.57"			
	5.000	9952.435	37200.106	64.549	71°35'58.27"			
IP 2	8.207	9957.820	37198.063	64.650		R = -10.450	16.415	89°59'59.55"
	10.000	9956.630	37202.738	64.711	44°11'06.98"			
	15.000	9959.142	37207.006	64.814	16°46'15.68"			
IP 3	16.415	9959.457	37208.384	64.825	9°00'50.01"			


KERB RETURN - RD1 RD2 HORIZONTAL POINTS

PT	CHAINAGE	EASTING	NORTHING	HEIGHT	BEARING	RAD/SPIRAL	A.LENGTH	DEFL.ANGLE
IP 1	0.000	9955.251	37181.866	64.691	9°00'50.01"			
	5.000	9954.846	37186.802	64.641	34°35'58.72"			
IP 2	8.207	9956.888	37192.187	64.583		R = -10.450	16.415	90°00'00.45"
	10.000	9952.213	37190.997	64.548	314°11'07.42"			
	15.000	994.7945	37193.509	64.482	286°46'16.13"			
IP 3	16.415	9946.567	37193.824	64.472	279°00'49.57"			

WARNING
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Rev	Amendments	Approved	Date
B	ISSUE FOR TENDER	K.H.	21-02-24
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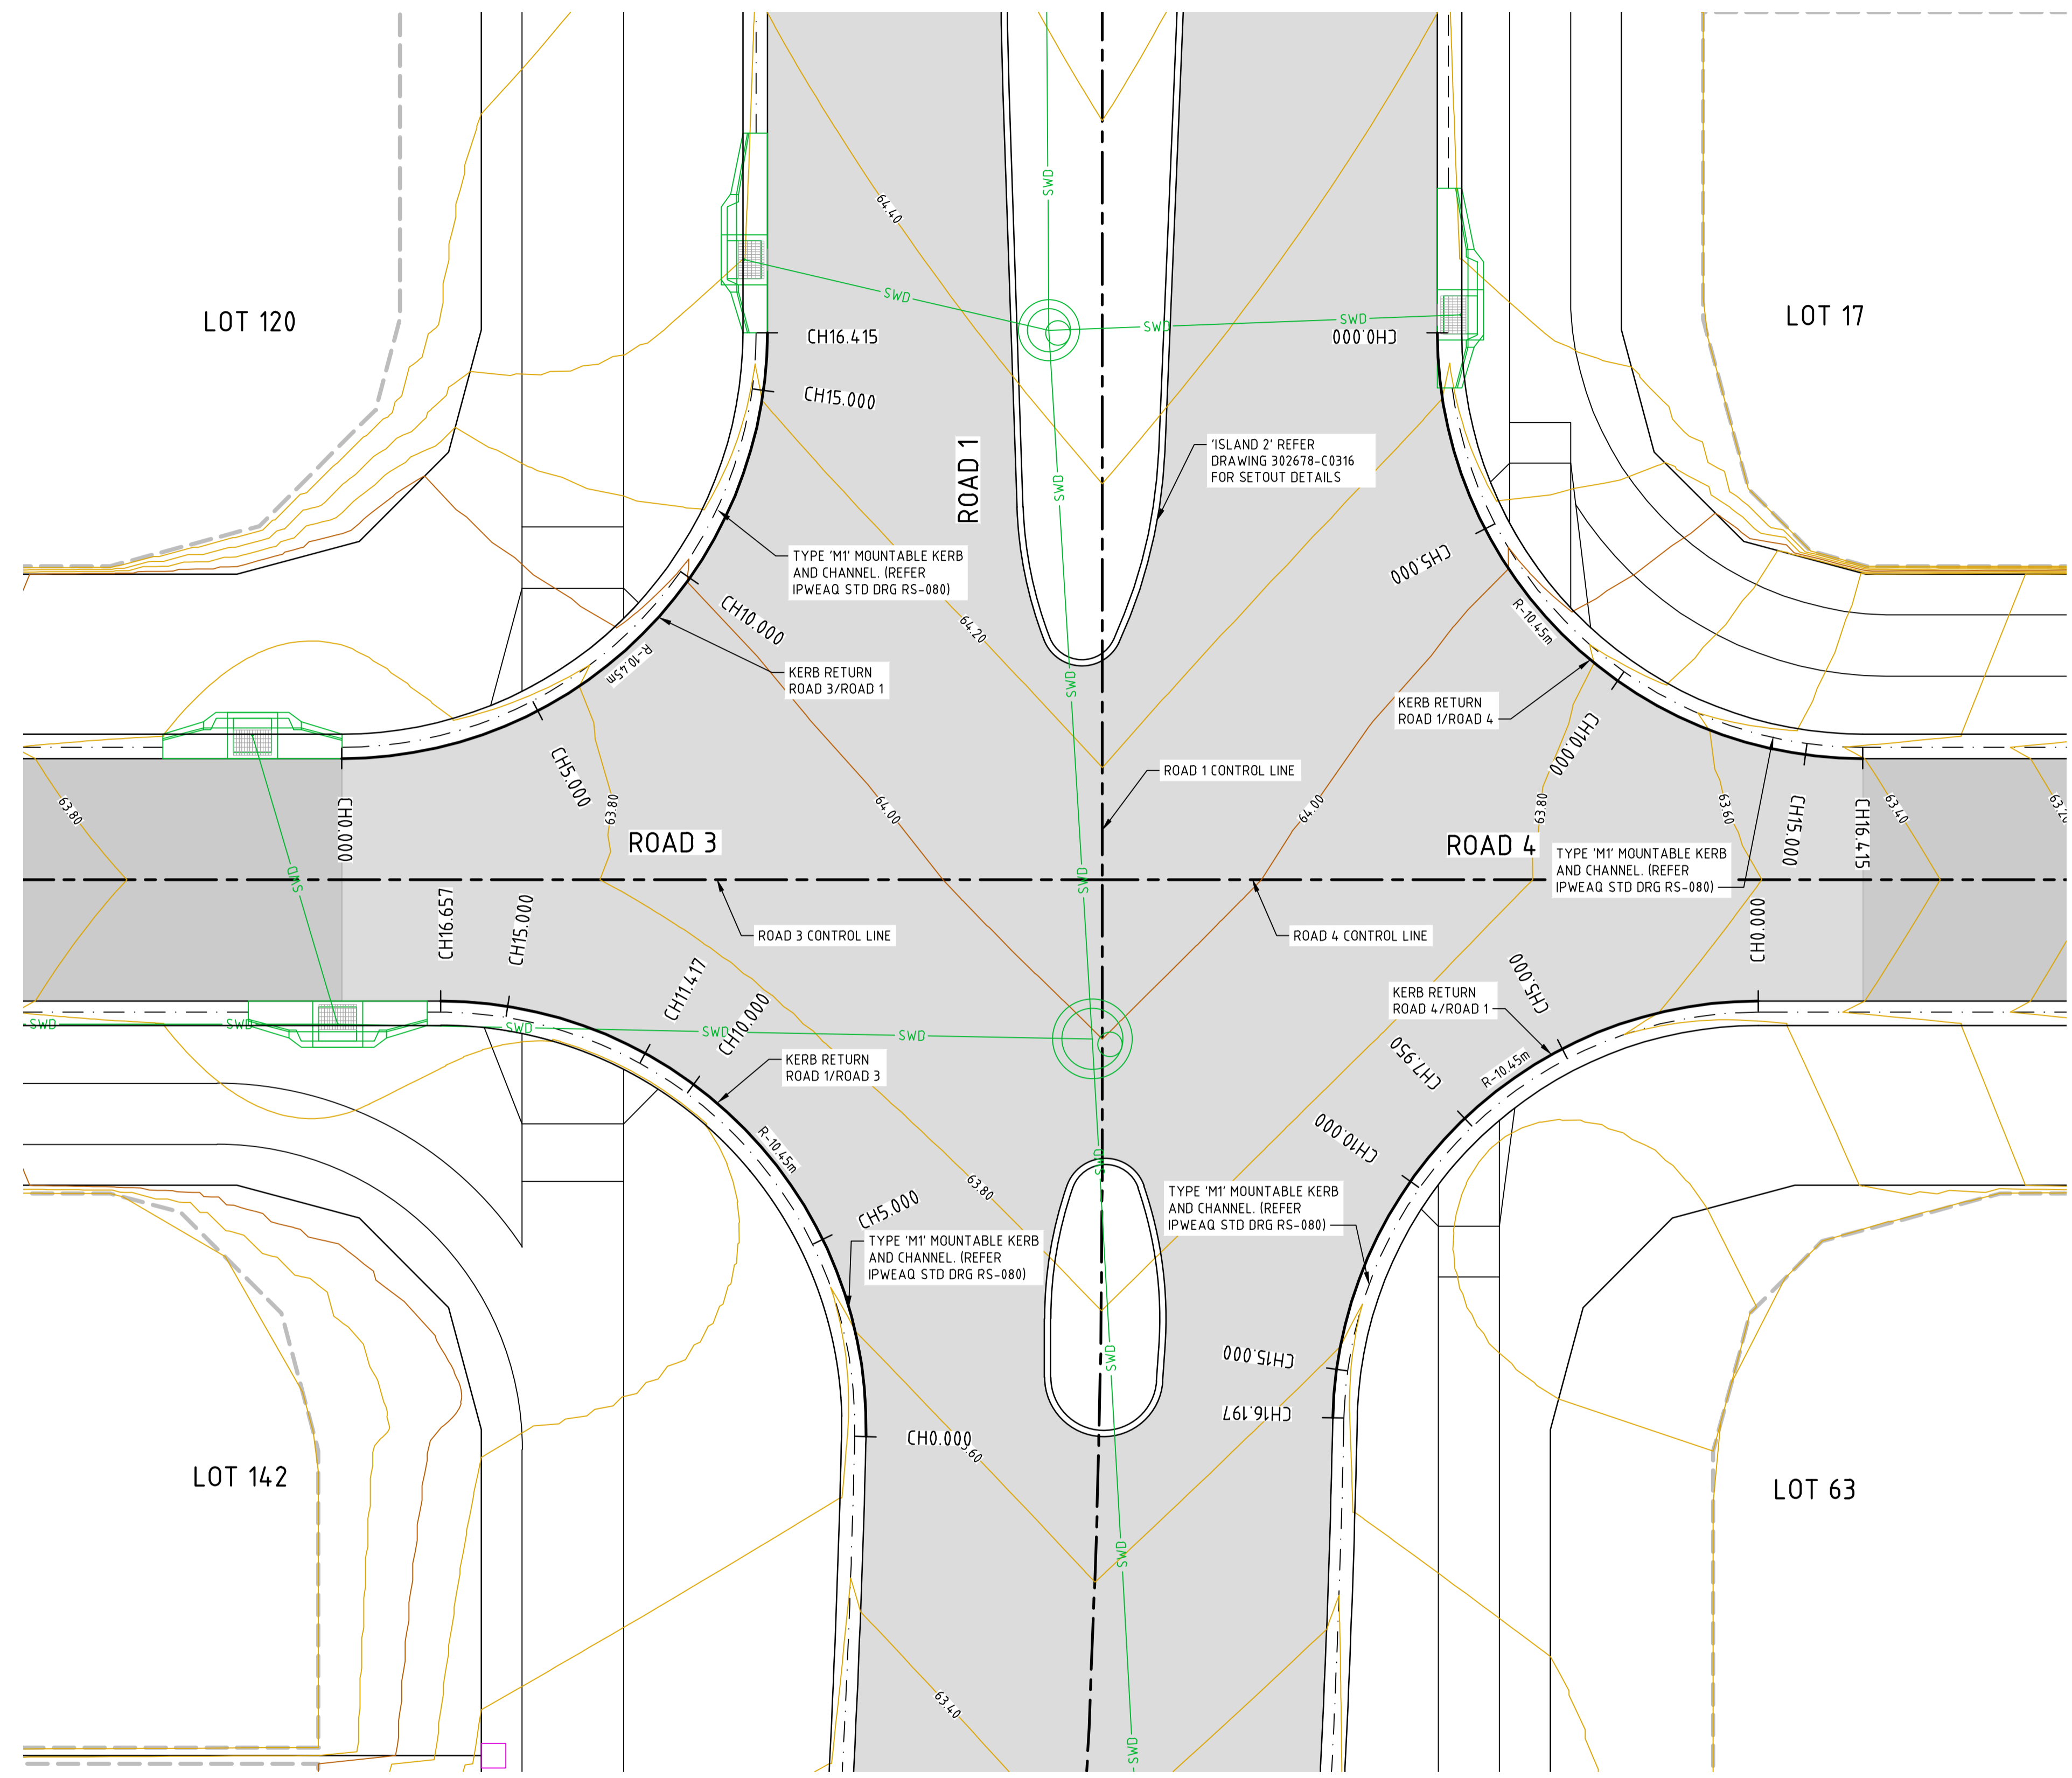
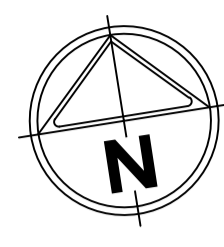
AMORY
AT RIPLEY

Designed: _____ Checked: _____
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AMORY AT RIPLEY
STAGE 01
ROAD 1/ROAD 2 INTERSECTION DETAIL

IPSWICH CITY COUNCIL
RIPLEY ROAD DEVELOPMENT PTY LTD

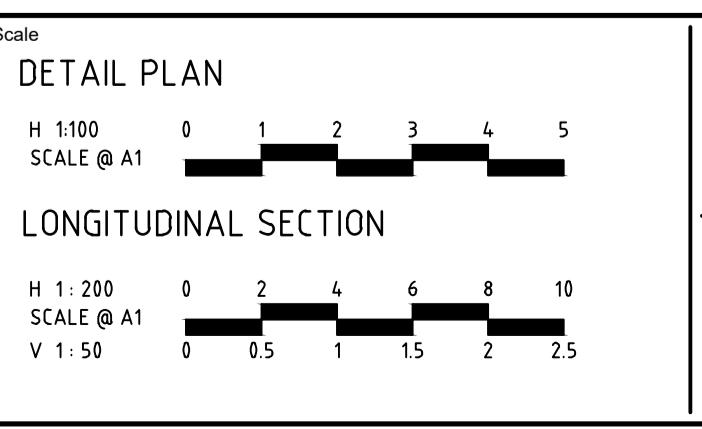PRELIMINARY Dwg No: 320678-01C0311 Rev: B




INTERSECTION DETAIL PLAN - ROAD 1/ROAD 3/ROAD4
SCALE 1:100

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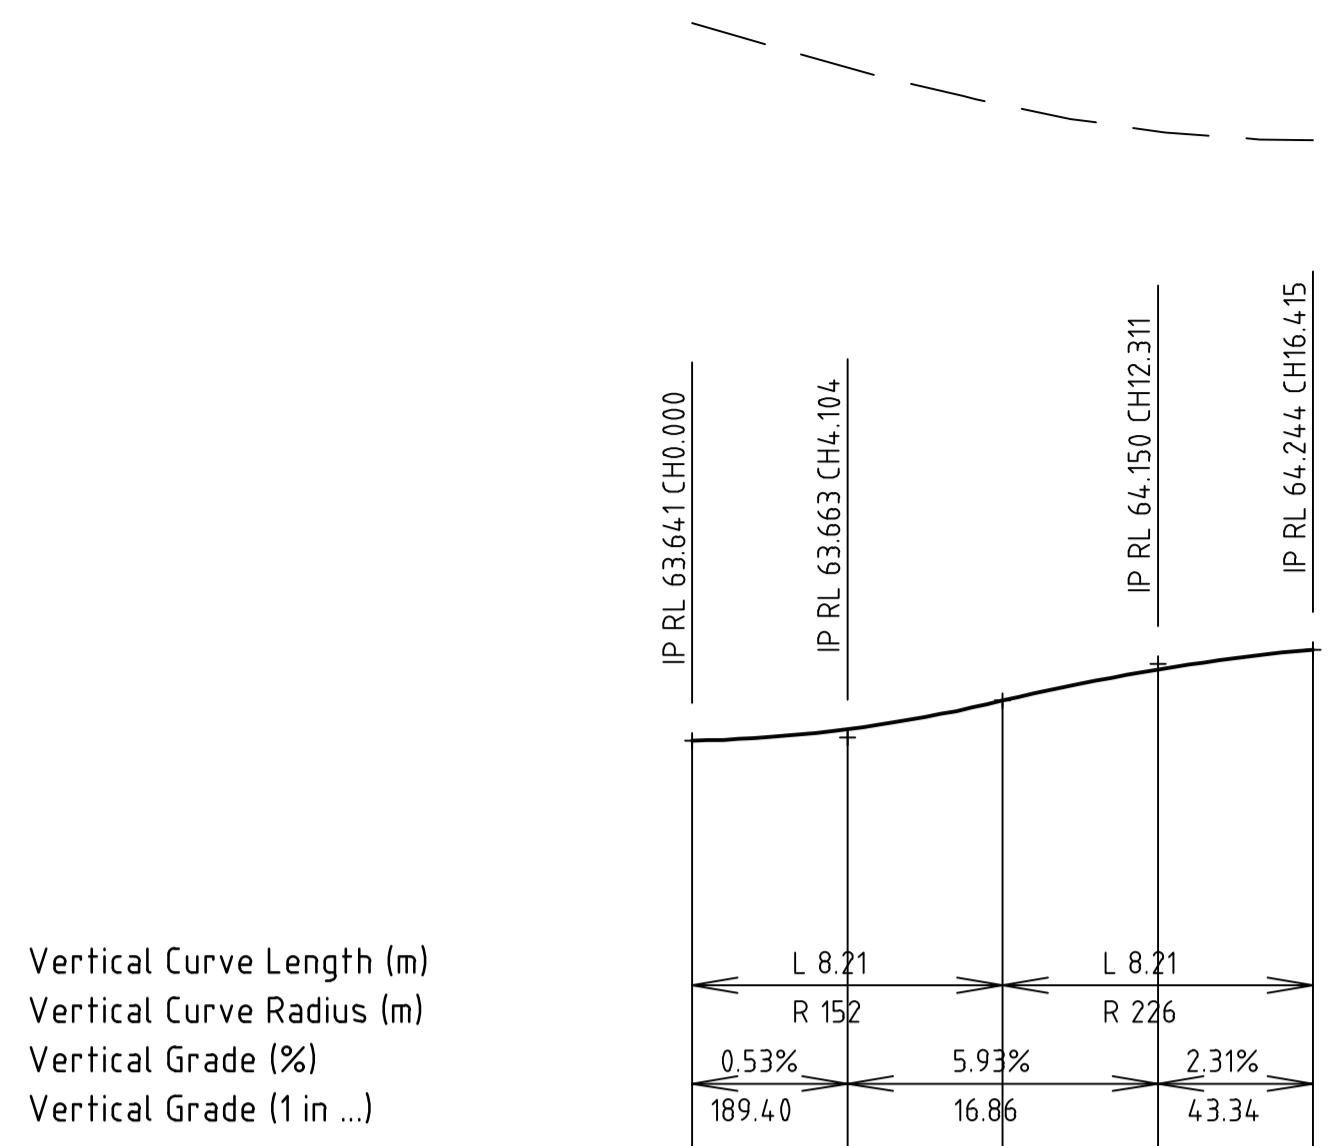
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AMORY AT RIPLEY
STAGE 01
 ROAD 1/ROAD 3 AND 4 INTERSECTION DETAIL
 SHEET 1 OF 2
 IPSWICH CITY COUNCIL
 RIPLEY ROAD DEVELOPMENT PTY LTD
PRELIMINARY

Drg No: 320678-01C0312
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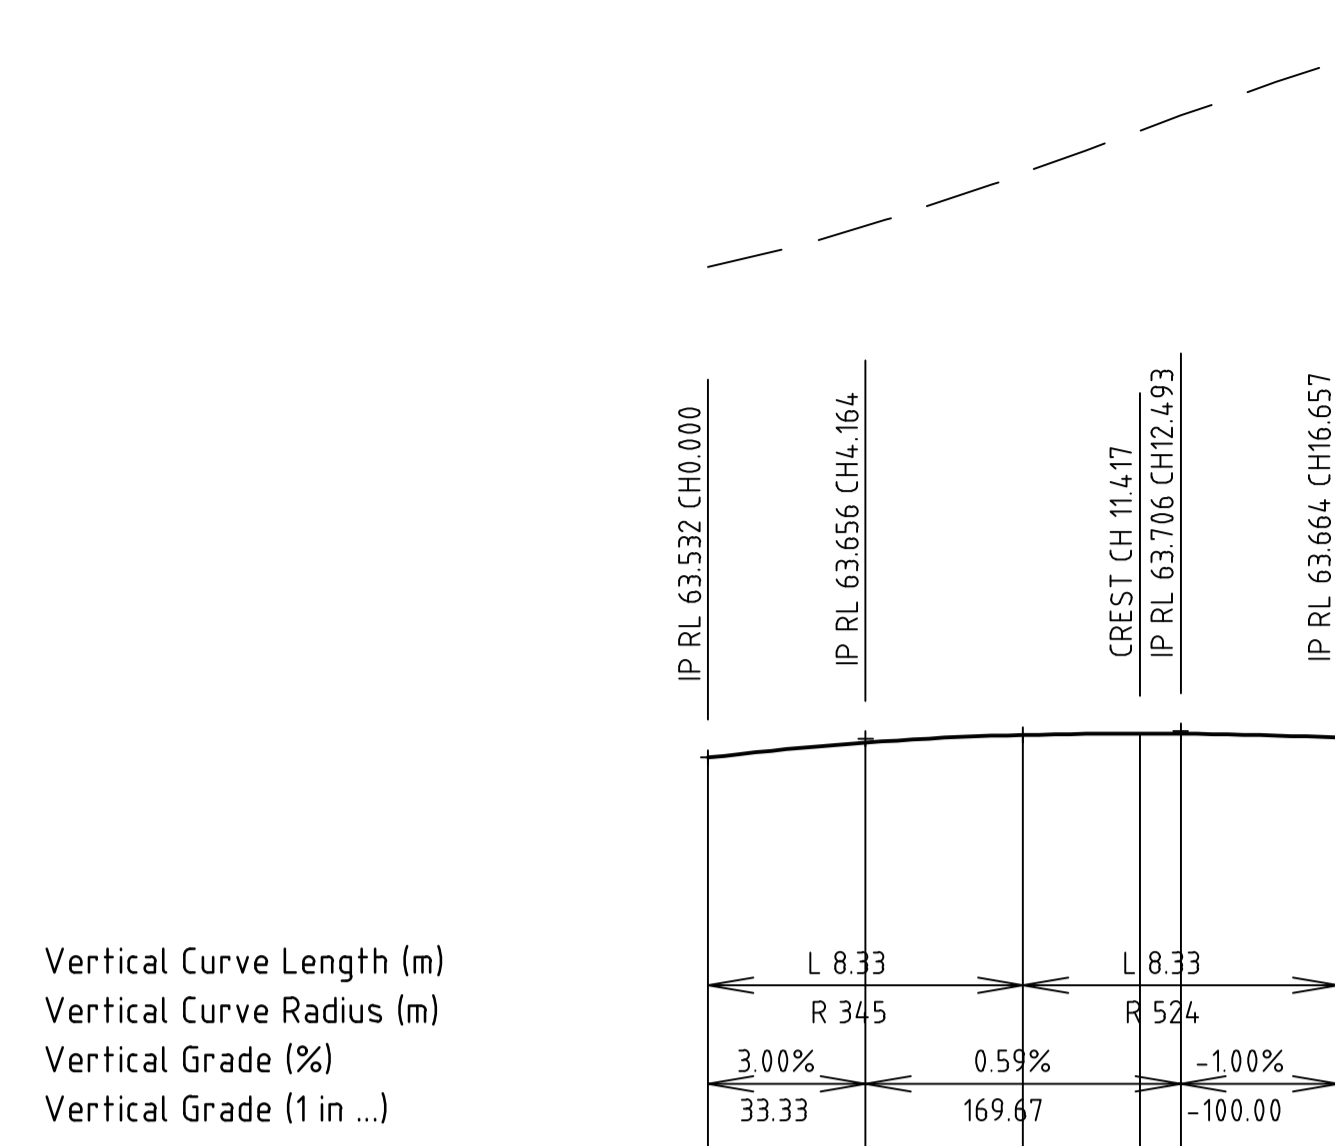
Vertical Curve Length (m)
Vertical Curve Radius (m)
Vertical Grade (%)
Vertical Grade (1 in ...)

DATUM RL60.000

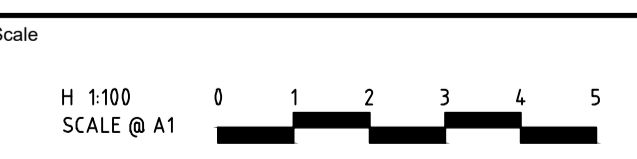CUT / FILL DEPTH	0.000	4.104	8.207	12.311	16.415
DESIGN LEVELS ON KERB LIP	63.641	63.718	63.906	64.113	64.244
EXISTING SURFACE ON KERB LIP	68.387	68.091	67.842	67.668	67.610
CHAINAGE	0.000	4.104	8.207	12.311	16.415

LONGITUDINAL SECTION - RD3 RD1

SCALE HORIZONTAL 1:200
VERTICAL 1:50




Vertical Curve Length (m)
Vertical Curve Radius (m)
Vertical Grade (%)
Vertical Grade (1 in ...)

DATUM RL60.000

CUT / FILL DEPTH	0.000	4.164	8.329	12.417	16.657
DESIGN LEVELS ON ROAD CL	63.532	63.631	63.681	63.690	63.664
EXISTING SURFACE ON ROAD CL	66.777	67.045	67.395	67.678	68.133
CHAINAGE	0.000	4.164	8.329	12.417	16.657

LONGITUDINAL SECTION - RD1 RD3

SCALE HORIZONTAL 1:200
VERTICAL 1:50

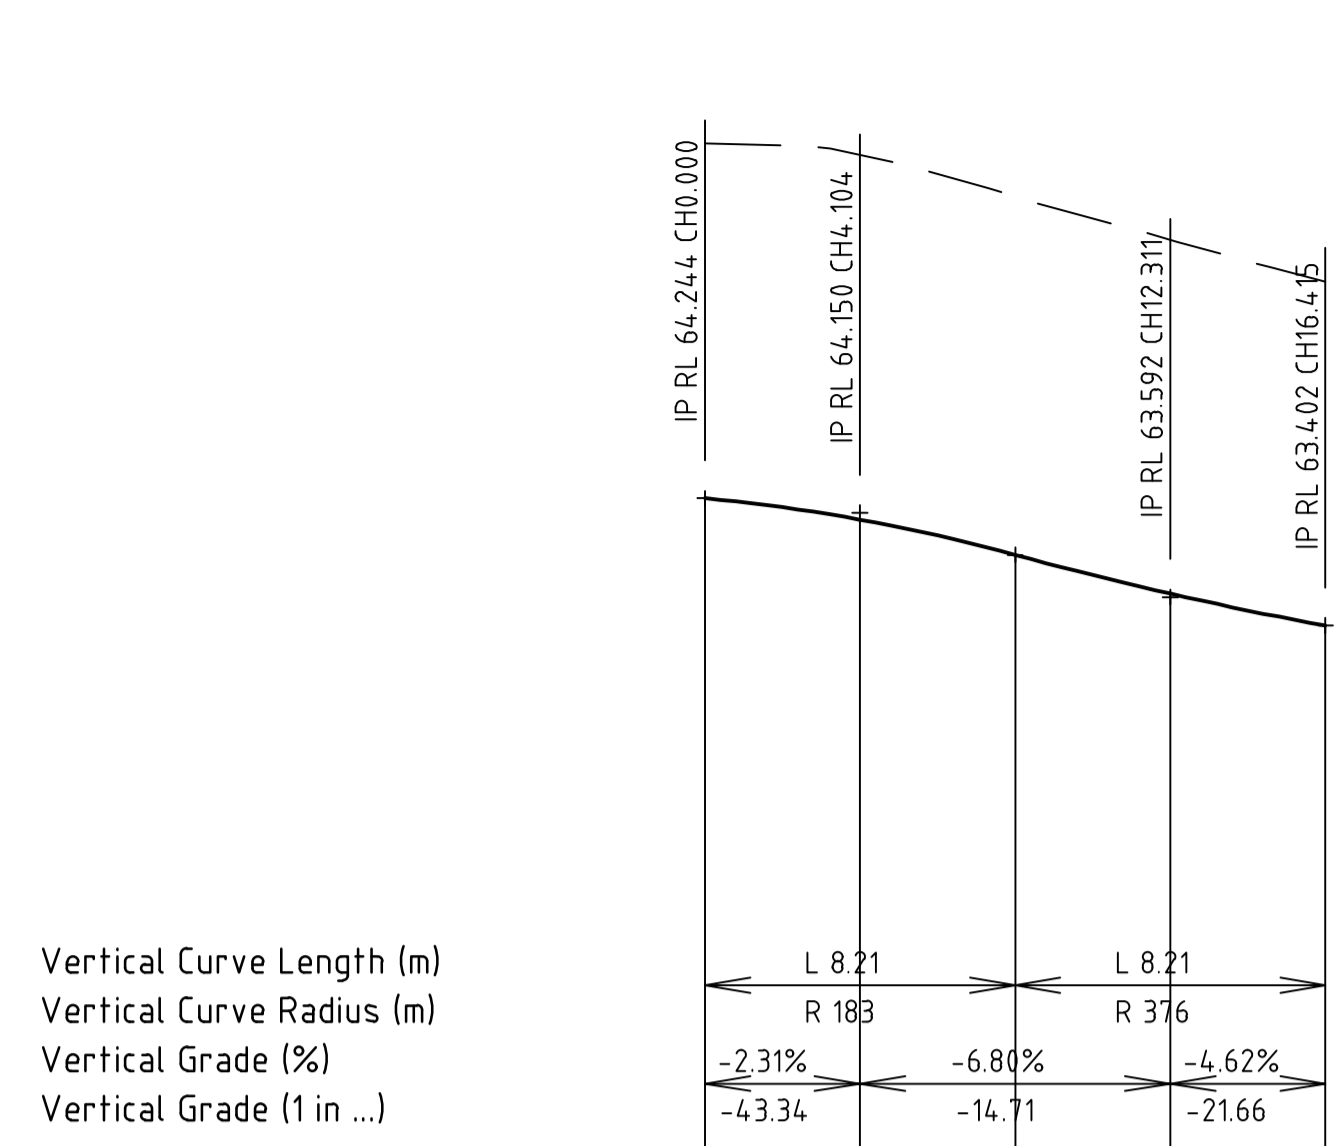


Vertical Curve Length (m)
Vertical Curve Radius (m)
Vertical Grade (%)
Vertical Grade (1 in ...)

DATUM RL59.000

CUT / FILL DEPTH	0.000	4.104	8.207	12.311	16.415
DESIGN LEVELS ON KERB LIP	64.244	64.104	63.871	63.614	63.402
EXISTING SURFACE ON KERB LIP	66.590	66.521	66.241	65.954	65.675
CHAINAGE	0.000	4.104	8.207	12.311	16.415

LONGITUDINAL SECTION - RD1 RD4

SCALE HORIZONTAL 1:200
VERTICAL 1:50

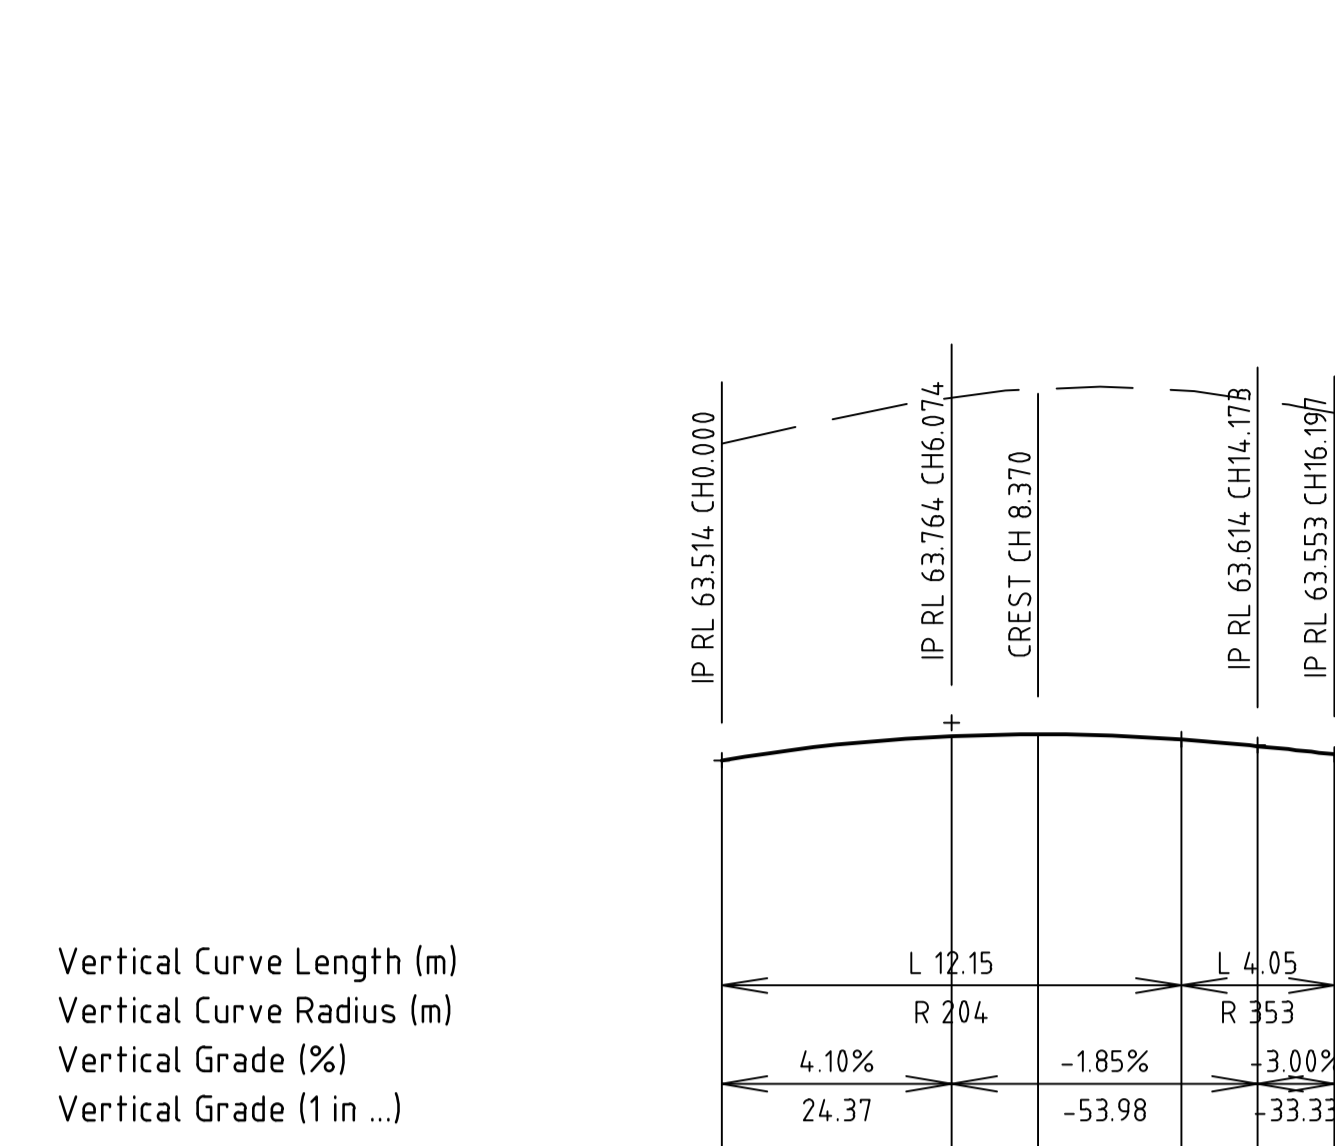

Vertical Curve Length (m)
Vertical Curve Radius (m)
Vertical Grade (%)
Vertical Grade (1 in ...)

DATUM RL60.000

CUT / FILL DEPTH	0.000	6.074	8.370	12.148	16.197
DESIGN LEVELS ON KERB LIP	63.514	63.673	63.686	63.651	63.553
EXISTING SURFACE ON KERB LIP	65.609	65.919	65.975	65.962	65.811
CHAINAGE	0.000	6.074	8.370	12.148	16.197

LONGITUDINAL SECTION - RD4/RD1

SCALE HORIZONTAL 1:200
VERTICAL 1:50

PT	CHAINAGE	EASTING	NORTHING	HEIGHT	BEARING	RAD/SPIRAL	A.LENGTH	DEFL.ANGLE
IP 1	0.000	9935.435	37123.652	63.641	99°00'49.79"			
	5.000	9940.371	37124.057	63.750	71°35'58.50"			
IP 2	8.207	9945.756	37122.014	63.906		R = -10.450	16.415	89°59'59.78"
	10.000	9944.566	37126.689	64.006	44°11'07.20"			
	15.000	9947.078	37130.957	64.207	16°46'15.91"			
IP 3	16.415	9947.394	37132.335	64.244	9°00'50.01"			

PT	CHAINAGE	EASTING	NORTHING	HEIGHT	BEARING	RAD/SPIRAL	A.LENGTH	DEFL.ANGLE
IP 1	0.000	9963.640	37129.758	64.244	189°00'50.01"			
	5.000	9964.046	37124.822	64.061	161°35'58.72"			
IP 2	8.207	9962.003	37119.437	63.871		R = -10.450	16.415	90°00'00.14"
	10.000	9966.678	37120.627	63.753	134°11'07.42"			
	15.000	9970.946	37118.115	63.470	106°46'16.13"			
IP 3	16.415	9972.324	37117.800	63.402	99°00'49.87"			


PT	CHAINAGE	EASTING	NORTHING	HEIGHT	BEARING	RAD/SPIRAL	A.LENGTH	DEFL.ANGLE
IP 1	0.000	9945.540	37105.198	63.532	10°20'35.69"			
	5.000	9945.249	37110.142	63.645	342°55'44.40"			
IP 2	8.329	9947.460	37115.720	63.681		R = -10.450	16.657	91°19'45.90"
	10.000	9942.715	37114.397	63.688	315°30'53.10"			
	15.000	9938.506	37117.007	63.678	288°06'01.81"			
IP 3	16.657	9936.897	37117.395	63.664	279°00'49.79"			

PT	CHAINAGE	EASTING	NORTHING	HEIGHT	BEARING	RAD/SPIRAL	A.LENGTH	DEFL.ANGLE
IP 1	0.000	9968.855	37112.326	63.514	279°00'49.87"			
	5.000	9963.919	37111.920	63.658	251°35'58.58"			
IP 2	8.099	9958.747	37113.929	63.686		R = -10.450	16.197	88°48'23.92"
	10.000	9959.724	37109.288	63.680	224°11'07.28"			
	15.000	9957.212	37105.020	63.587	196°46'15.99"			
IP 3	16.197	9956.933	37103.857	63.553	190°12'25.96"			

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B	ISSUE FOR TENDER	K.H.	21-02-24
A	ISSUE FOR APPROVAL	K.H.	01-12-23
	Amendments	Approved	Date




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AMORY AT RIPLEY
STAGE 01
 ROAD 1/ROAD 3 AND 4 INTERSECTION DETAIL
SHEET 2 OF 2
 IPSWICH CITY COUNCIL
 RIPLEY ROAD DEVELOPMENT PTY LTD
PRELIMINARY Dwg No **320678-01C0313** Rev **B**

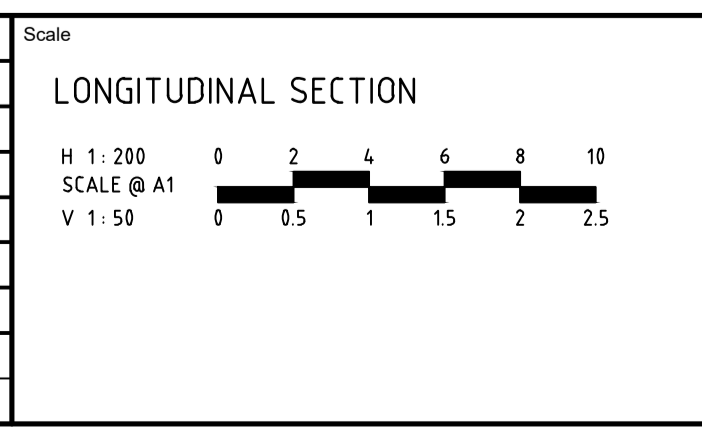

TRAFFIC ISLAND 1, 2 & 3 DETAIL PLAN

SCALE 1:200

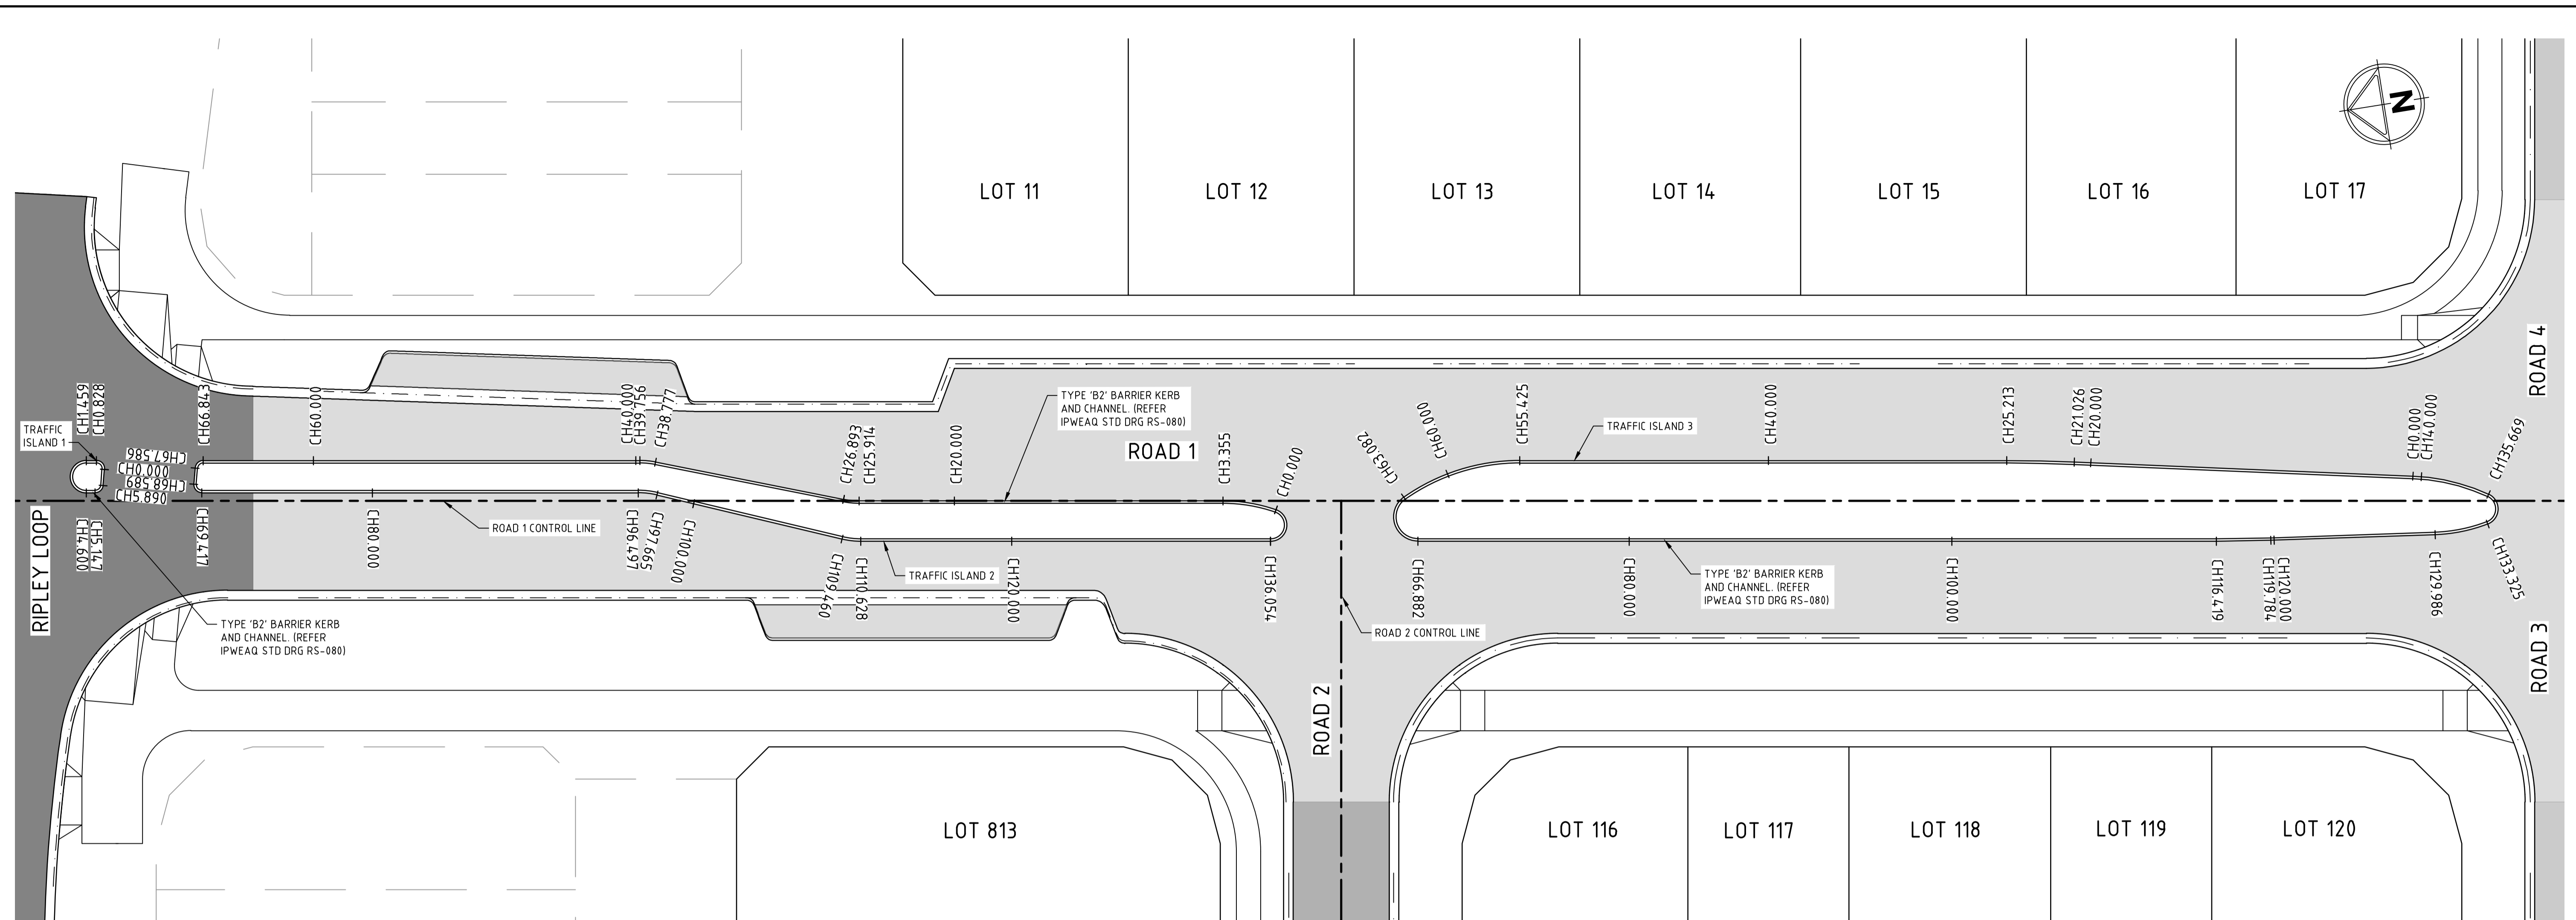ISLAND 1 SETOUT - HORIZONTAL POINTS

PT	CHAINAGE	EASTING	NORTHING	HEIGHT	BEARING	RAD/SPIRAL	A.LENGTH	DEFL.ANGLE
IP 1	0.000	9979.430	37269.295	64.252	103°50'25.63"			
IP 2	0.414	9979.958	37269.165	64.248		R = -0.500	0.828	94°49'35.56"
CT	0.828	9980.043	37269.702	64.251	9°00'50.07"			
TC	1.459	9980.142	37270.325	64.267	9°00'50.07"			
IP 3	2.244	9980.299	37271.313	64.296		R = -1.000	1.571	90°00'00.00"
CT	3.029	9979.311	37271.470	64.323	279°00'50.07"			
IP 4	3.815	9978.324	37271.626	64.333		R = -1.000	1.571	90°00'00.00"
CT	4.600	9978.167	37270.639	64.324	189°00'50.07"			
TC	5.147	9978.081	37270.099	64.308	189°00'50.07"			
IP 5	5.518	9978.009	37269.645	64.295		R = -0.500	0.743	85°10'24.44"
CT	5.890	9978.455	37269.535	64.282	103°50'25.63"			
IP 6	6.894	9979.430	37269.295	64.252	103°50'25.63"			

ISLAND 2 SETOUT - HORIZONTAL POINTS

PT	CHAINAGE	EASTING	NORTHING	HEIGHT	BEARING	RAD/SPIRAL	A.LENGTH	DEFL.ANGLE
IP 1	0.000	9965.562	37197.920	65.008	28°14'26.56"			
IP 2	1.677	9966.364	37199.412	65.027		R = -9.995	3.355	19°13'58.75"
IP 3	3.355	9966.629	37201.084	65.042				
TC	25.914	9970.162	37223.365	65.155	9°00'36.21"			
IP 4	26.403	9970.239	37223.850	65.156		R = 5.000	0.979	11°12'50.84"
CT	26.893	9970.408	37224.311	65.157	20°13'27.05"			
TC	38.777	9974.517	37235.462	65.083	20°13'27.05"			
IP 5	39.266	9974.686	37235.923	65.077		R = -5.000	0.979	11°12'46.51"
CT	39.756	9974.763	37236.408	65.070	9°00'40.53"			
IP 6	66.843	9979.006	37263.160	64.183				
IP 7	67.214	9979.078	37263.614	64.185		R = -0.500	0.743	85°10'14.04"
CT	67.586	9978.632	37263.724	64.189	283°50'25.63"			
TC	68.589	9977.657	37263.964	64.217	283°50'25.63"			
IP 8	69.003	9977.129	37264.094	64.230		R = -0.500	0.828	94°49'45.96"
CT	69.417	9977.044	37263.557	64.241	189°00'39.67"			
TC	96.497	9972.802	37236.811	65.129	189°00'39.67"			
IP 9	97.081	9972.711	37236.232	65.137		R = 5.000	1.168	13°23'04.93"
CT	97.665	9972.487	37235.690	65.146	202°23'44.60"			
TC	109.460	9967.993	37224.784	65.089	202°23'44.60"			
IP 10	110.044	9967.770	37224.242	65.083		R = -5.000	1.168	13°22'54.53"
CT	110.628	9967.678	37223.662	65.079	189°00'50.07"			
TC	136.054	9963.694	37198.550	64.947	189°00'50.07"			
IP 11	136.755	9963.562	37197.716	64.951		R = -1.000	1.403	80°22'24.07"
CC	137.456	9964.362	37197.446	64.969	108°38'26.01"			
IP 12	138.158	9965.162	37197.176	64.990		R = -1.000	1.403	80°22'24.07"
IP 13	138.859	9965.562	37197.920	65.008	28°16'01.94"			

ISLAND 3 SETOUT - HORIZONTAL POINTS


PT	CHAINAGE	EASTING	NORTHING	HEIGHT	BEARING	RAD/SPIRAL	A.LENGTH	DEFL.ANGLE
IP 1	0.000	9956.579	37127.939	64.374	11°24'32.43"			
TC	21.026	9960.739	37148.549	64.700	11°24'32.43"			
IP 2	23.120	9961.153	37150.602	64.712		R = -100.000	4.188	2°23'57.66"
CT	25.213	9961.481	37152.670	64.724	9°00'34.76"			
IP 3	55.425	9966.212	37182.509	64.875				
IP 4	59.253	9966.831	37186.413	64.912		R = -12.500	7.657	35°05'48.49"
CC	63.082	9965.093	37189.963	64.979	333°55'01.58"			
IP 5	64.032	9964.609	37190.953	64.970		R = -1.500	1.900	72°34'58.89"
CC	64.982	9963.520	37190.787	64.938	261°20'02.70"			
IP 6	65.932	9962.431	37190.621	64.910		R = -1.500	1.900	72°34'58.89"
IP 7	66.882	9962.263	37189.532	64.896				
TC	116.419	9954.506	37140.607	64.595	189°00'36.21"			
IP 8	118.102	9954.242	37138.944	64.567		R = -100.000	3.366	1°55'42.10"
CT	119.784	9954.035	37137.274	64.540	187°04'54.11"			
TC	129.986	9952.777	37127.150	64.321	187°04'54.11"			
IP 9	131.656	9952.569	37125.478	64.282		R = -10.000	3.339	19°08'01.43"
CC	133.325	9952.921	37123.830	64.248	167°56'52.68"			
IP 10	133.911	9953.060	37123.181	64.249		R = -1.000	1.172	67°08'48.68"
CC	134.497	9953.712	37123.056	64.260	100°48'04.00"			
IP 11	135.083	9954.364	37122.932	64.277		R = -1.000	1.172	67°08'48.68"
CC	135.669	9954.731	37123.484	64.278	33°39'15.32"			
IP 12	138.096	9956.093	37125.530	64.321		R = -12.500	4.853	22°14'42.89"
IP 13	140.522	9956.579	37127.939	64.374	11°24'32.43"			

WARNING

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file name: 320678-01C0314.dwg, layout name: C0314, plotted by: Michael Barmann, file location: C:\Users\mbarman\OneDrive\Documents\320678-01C0314.dwg, plot date: 23/02/2024, 3:59 PM, Sheet # of # Sheets

Rev	Description	Approved	Date
B	ISSUE FOR TENDER	K.H.	21-02-24
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	Amendments		

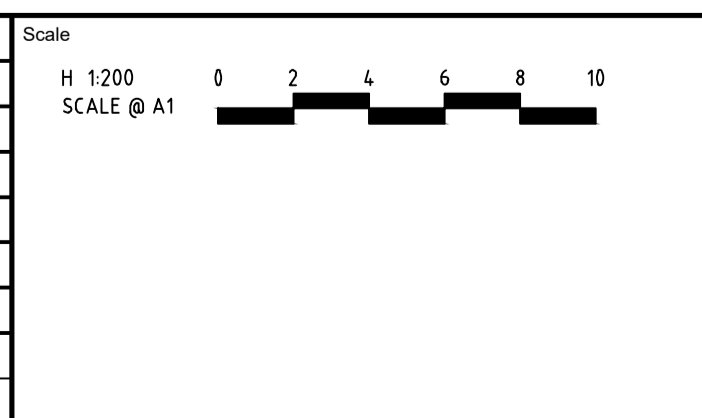

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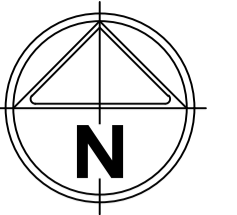
AMORY
 AT RIPLEY

Designed: _____ Checked: _____
 Authorised: _____ Date: DECEMBER 23

AMORY AT RIPLEY
 STAGE 01
 TRAFFIC ISLAND SETOUT DETAILS

IPSWICH CITY COUNCIL
 RIPLEY ROAD DEVELOPMENT PTY LTD

PRELIMINARY Dwg No: 320678-01C0314 Rev: B



- NOTES**
1. T.G.S.I's TO BE PROVIDED FOR ALL KERB RAMPs AT SIGNALISED INTERSECTION, REFER TO ICC STD DWG SR.18 FOR DETAILS.
 2. ALL PAVEMENT MARKINGS AND SIGNAGE TO BE IN ACCORDANCE WITH TMR AND AS1742 MANUAL FOR UNIFORM TRAFFIC CONTROL DEVICES.
 3. FOR SIGNAGE AND ASSEMBLY DETAILS REFER TMR MANUAL OF UNIFORM CONTROL DEVICES.
 4. EXISTING PAVEMENT MARKING ARE TO BE REMOVED BY GRINDING.
 5. LINEMARKING SHALL BE DULUX ROADMASTER WATER BASED PAVEMENT MARKING OR APPROVED EQUIVALENT.

LINEMARKING LEGEND:


SYMBOL:	DESCRIPTION:	REMARK:
	DIAGONAL AND CHEVRON MARKINGS	AS1742.2 CLAUSE 5.6
	SINGLE CONTINUOUS LANE LINE	CONTINUOUS LINE, 100mm WIDE. AS1742.2 CLAUSE 5.3
	CONTINUITY LINE	1m LINE, 3m GAP, 150mm WIDE. AS1742.2 CLAUSE 5.3
	STOP LINE	CONTINUOUS LINE, 450mm WIDE. AS1742.2 CLAUSE 5.5 & AS1742.14 CLAUSE 6.2.1
	TURN LINE	600mm LINE, 600mm GAP, 100mm WIDE. AS1742.2 CLAUSE 5.3 & AS1742.14 CLAUSE 6.2.4
	PEDESTRIAN GUIDE LINE	1m LINE 300mm GAP, 150mm WIDE. AS1742.2 CLAUSE 5.5 & AS1742.14 CLAUSE 6.2.3
	GIVE WAY LINE	600mm LINE, 600mm GAP, 450mm WIDE. AS1742.2 CLAUSE 5.5
	INTERSECTION ARROW	AS1742.2 CLAUSE 5.7 & AS1742.14 CLAUSE 6.2.2
	LINEMARKING TO BE REMOVED	
	BICYCLE LANE GREEN PAINTED SURFACE	SECTION 6.6-1, PART 10, TRUM MANUAL VOL. 1. APPROVED COLOUR EMERALD GREEN G13
	BICYCLE SYMBOL (ROAD)	AS1742.2 CLAUSE 5.8 FIGURE 5.41
	BICYCLE SYMBOLS (PATH)	AS1742.2 CLAUSE 5.8 FIGURE 5.44
	SINGLE BROKEN DIVIDING LINE - PATH	1m LINE, 3m GAP, 100mm WIDE. AS1742.2 CLAUSE 5.3

WARNING
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SIGNS & LINEMARKING LAYOUT PLAN
SCALE 1:500

file name: 320678-01C0400.dwg, layout name: C0400, plotted by: Michael B...
file location: C:\Users\michaelb\OneDrive\Documents\320678-01C0400.dwg, 4:00 PM Sheet # of # Sheets

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A	ISSUE FOR APPROVAL	K.H.	01-12-23

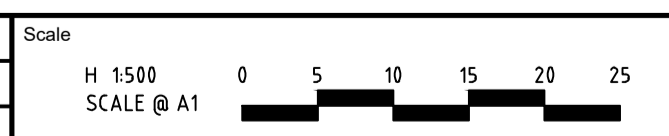

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AMORY AT RIPLEY

STAGE 01

SIGNAGE & LINEMARKING LAYOUT PLAN

 IPSWICH CITY COUNCIL

 RIPLEY ROAD DEVELOPMENT PTY LTD

 Drg No: 320678-01C0400 Rev: B

STORMWATER DRAINAGE NOTES:

- ALL DRAINAGE MATERIALS, EXCAVATION AND CONSTRUCTION SHALL COMPLY WITH THE APPLICABLE LOCAL AUTHORITY SPECIFICATIONS AND DETAILS AND THE FOLLOWING PUBLICATIONS (AS APPLIES TO THE TYPE OF PIPELINE):-
 - CONCRETE PIPE ASSOCIATION OF AUSTRALIA TECHNICAL ADVISORY PUBLICATIONS
 - AS 3725 "DESIGN FOR THE INSTALLATION OF BURIED CONCRETE PIPES"
 - AS 4058 "PRE-CAST CONCRETE PIPES (PRESSURE AND NON-PRESSURE)"
 - AS 4139 "FIBRE REINFORCED CONCRETE PIPES AND FITTINGS"
 - AS 2566 "BURIED FLEXIBLE PIPELINES"
 - AS 3500 "NATIONAL PLUMBING CODE"
 - AS 1254 "PVC PIPES AND FITTINGS FOR STORM & SURFACE WATER APPLICATIONS"
 - AS 1273 "UNPLASTICIZED PVC (uPVC) DOWNPIPE AND FITTINGS FOR RAINWATER"
- WHERE THE DEPTH OF FILL OVER THE PIPE IS BETWEEN Min. 600mm AND Max. 1.5m HIGH:-
 - ALL uPVC PIPES SHALL BE CLASS "SN8" FOR 150φ - 225φ AND "SN6" FOR 100φ
 - ALL CONCRETE PIPES SHALL BE MINIMUM CLASS "2"
 SHOULD THE DEPTH OF COVER OVER THE PIPE BE OUTSIDE THE ABOVE MAXIMUM AND MINIMUM LIMITS, OR ANY LOADING OTHER THAN NORMAL EARTH LOADS BE APPLICABLE (INCLUDING CONSTRUCTION TRAFFIC LOADS) THE DESIGN ENGINEER MUST BE CONTACTED FOR SPECIFIC DESIGN OF PIPE CLASS.
- UNLESS DETAILED OTHERWISE PIPE CLASSES SPECIFIED ON PROJECT DRAWINGS ARE BASED ON SINGLE PIPE BARREL ONLY - WHERE MULTIPLE PIPE BARRELS ARE PROPOSED THE PIPE CLASS MUST BE REFERRED TO THE DESIGN ENGINEER FOR CONFIRMATION.
- UNLESS SPECIFIED OTHERWISE DESIGN LOADING ON ALL PIPELINES REQUIRE "TRENCH" TYPE BEDDING AND BACKFILL INSTALLATION IN ACCORDANCE WITH AS 3725. "EMBANKMENT" TYPE INSTALLATION WILL NOT BE ACCEPTED WITHOUT WRITTEN APPROVAL. STABILITY OF TRENCH BASE AND SIDES MUST BE ADEQUATE TO PROVIDE REQUIRED SUPPORT TO THE BEDDING, HAUNCH AND SIDES OF THE TRENCH - IF ANY DOUBT EXISTS THE CONTRACTOR MUST OBTAIN GEOTECHNICAL CONSULTANT CONFIRMATION.
- THE WIDTH OF TRENCH OUTSIDE THE PIPE SHALL BE IN ACCORDANCE WITH AS 3725 (NOMINAL 300mm Max.). ANY FURTHER WIDENING OF THE TRENCH WILL INCREASE LOAD ONTO PIPE, AND WILL REQUIRE REVIEW OF PIPE CLASS AND INSTALLATION SPECIFICATIONS. ANY ADDITIONAL ASSOCIATED PIPE OR SUPPORT COSTS WILL BE AT CONTRACTOR'S EXPENSE.
- UNLESS SPECIFIED OTHERWISE PIPE BEDDING AND SUPPORT SHALL BE INSTALLED IN ACCORDANCE WITH AS 3725 AND SHALL BE GENERALLY AS FOLLOWS:-
 - "HS2" UNDER ROADWAYS
 - "H2" UNDER NON-TRAFFIC / NON-LOADED AREAS
 ANY CIRCUMSTANCES OUTSIDE THESE MUST BE REFERRED TO THE DESIGN ENGINEER FOR PIPE SUPPORT SPECIFICATIONS.
- THE CONTRACTOR SHALL ENSURE THAT ALL CONSTRUCTION TRAFFIC LOADING ONTO PIPELINES IS LIMITED TO MAXIMUM VEHICLE LOADINGS AND ACHIEVES BACKFILL COVER IN ACCORDANCE WITH AS 3725 (OR ALTERNATIVELY PROVIDE ADEQUATE TEMPORARY AND PERMANENT BRIDGING). REFER C.P.A.A. PIPE CLASS SELECTION CRITERIA / SOFTWARE FOR ACCEPTABLE LOADING APPLICATIONS.
- ANY DRAINLINE BEING INSTALLED WITH ANY PORTION OF THE DRAINLINE BELOW THE MAXIMUM TIDAL LEVEL SHALL HAVE SALTWATER EXPOSURE COVER CLASS PIPES OR CULVERTS INSTALLED. FOR ANY DEVELOPMENT WITHIN 1 KILOMETRE OF THE COASTLINE, OR WITH PIPEWORK THE HIGHEST ASTRONOMICAL TIDE (H.A.T.) THE CONTRACTOR MUST VERIFY THIS REQUIREMENT WITH THE SUPERVISING ENGINEER.
- WHERE DRAINLINES ARE TO BE INSTALLED IN "AGGRESSIVE" PERMEABLE SOILS AS DEFINED IN AS 3600, OR ACID SULPHATE SOILS (pH <4.0) THEY MUST BE REFERRED TO THE SUPERVISING ENGINEER FOR REVIEW OF PIPE / EXPOSURE COVER CLASS. THE CONTRACTOR SHALL VERIFY SOIL CONDITION (BY TESTING) AND UNDERTAKE SOIL REMEDIATION TREATMENT (WHERE REQUIRED) PRIOR TO DRAINLINE CONSTRUCTION.
- MINIMUM AND MAXIMUM PIPE GRADES SHALL BE IN ACCORDANCE WITH Q.U.D.M. SPECIFICATIONS. (N.B. 150φ=1% Min. AND 375φ=0.4% Min.)
- ANY PIPE DOWNSTREAM OF INLETS CAPTURING GROUND RUNOFF SHALL BE Min. 150φ.
- WHERE PIPES AND STRUCTURES ARE TO BE LAID WITHIN THE ZONE OF INFLUENCE OF STRUCTURAL ELEMENTS (e.g. BUILDING FOOTINGS, RETAINING WALLS . . . etc.) THE BUILDER SHALL PROVIDE ADEQUATE BRIDGING / PROTECTION TO ENSURE NO UNDUE LOADING ONTO STORMWATER PIPES AND STRUCTURES. WHERE ANY DOUBT MAY EXIST REFERENCE SHALL BE MADE TO THE DESIGNER OF THE STRUCTURE AND THE STORMWATER DESIGN ENGINEER.
- CONTRACTOR MUST VERIFY THAT ALL PIPE LEVELS AND GRADES CAN BE ACHIEVED PRIOR TO CONSTRUCTING DRAINLINES. ANY CONFLICT SHALL BE REFERRED TO THE SUPERINTENDENT FOR RE-DESIGN PRIOR TO ANY PIPELINE CONSTRUCTION.
- BENCHING OF PIT STRUCTURES SHALL HAVE A SMOOTH FINISHED SURFACE, AND PIPES SHALL NOT PROJECT INSIDE THE SHAFT OF THE PIT.
- WHERE RECTANGULAR PITS OR STRUCTURES ARE CONSTRUCTED, PIPES MUST NOT CONNECT INTO THE STRUCTURE AT CORNERS.

- ALL CONSTRUCTION AND EXCAVATIONS SHALL BE CARRIED OUT IN ACCORDANCE WITH THE REQUIREMENTS OF THE CURRENT WORKPLACE HEALTH AND SAFETY ACT INCLUDING AMENDMENTS SUBSEQUENT TO THE ORIGINAL PUBLICATION.
- BASE AND SHAFT OF ALL STORMWATER STRUCTURES SHALL BE "CAST IN-SITU" CONCRETE UNLESS OTHERWISE APPROVED IN WRITING BY THE SUPERVISING ENGINEER.
- ALL GRATED INLETS SHALL BE MINIMUM "CLASS D" TRAFFICABLE, AND SHALL BE BOLTED DOWN UNLESS OTHERWISE APPROVED BY THE SUPERVISING ENGINEER.
- WHERE A BRANCH CONNECTION IS INDICATED DIRECTLY ONTO THE RECEIVING PIPELINE (I.E. WITHOUT JUNCTION PIT) - A PROPRIETARY OBLIQUE BRANCH FITTING SHALL BE INSTALLED ONTO RECEIVING PIPELINE SIZE UP TO 300MM, OR APPROVED SADDLE BRANCH INSTALLED IN STRICT ACCORDANCE WITH MANUFACTURER SPECIFICATIONS FOR PIPES FOR RECEIVING PIPELINE SIZE 375MM OR GREATER. THE MAXIMUM SIZE OF THE CONNECTING BRANCH LINE (WITHOUT JUNCTION PIT) SHALL BE 150MM U.N.O.
- ALL PIPED OUTLETS AND INLETS MUST BE PROVIDED WITH CEMENT GROUTED STONE PITCHING SCOUR PROTECTION IN ACCORDANCE WITH IPWEA STANDARD DRAWING NUMBER D-0081. ALL VOIDS BETWEEN STONES MUST BE CEMENT GROUTED - NO SHALL NOT BE LOOSE STACKED. ALL STONE PITCHING SHALL BE PLACED OVER GEOFABRIC - BIDIM A24 OR EQUIVALENT.

STORMWATER DESIGN CRITERIA:


- STORMWATER HAS BEEN DESIGNED IN ACCORDANCE WITH QUEENSLAND URBAN DRAINAGE MANUAL (Q.U.D.M.) AND BRISBANE COUNCIL PLANNING SCHEME, POLICIES & DEVELOPMENT STANDARDS.
- STORMWATER DESIGN EVENTS ADOPTED ARE AS FOLLOWS:-
 - "MINOR STORM" PIPED SYSTEM - 10 YEAR A.R.I.
 - "MAJOR STORM" OVERLAND FLOW - 100 YEAR A.R.I.
- CATCHMENT LABELS CORRELATE TO INLET STRUCTURE LABELS U.N.O.

NOTES:


- ALL STORMWATER PIPELINES SHALL BE INSTALLED WITH TYPE "HS2" EMBEDMENT IN ACCORDANCE WITH AS 3725.
- ALL STORMWATER STRUCTURE COVERS SHALL BE CLASS 'D' TRAFFICABLE U.N.O.
- PIPE CLASS NOMINATED ON LONGITUDINAL SECTIONS ARE AS FOLLOWS;
 - U = uPVC CLASS "SN8"
 - 2 = RCP CLASS '2'
 - 3 = RCP CLASS '3'
 - 4 = RCP CLASS '4'

ROOFWATER CONNCTION NOTE:

- LOTS SHALL BE PROVIDED WITH KERB ADAPTER INSTALLED INTO KERB & CHANNEL IN ACCORDANCE WITH IPWEA STANDARD DRAWING RS-081.

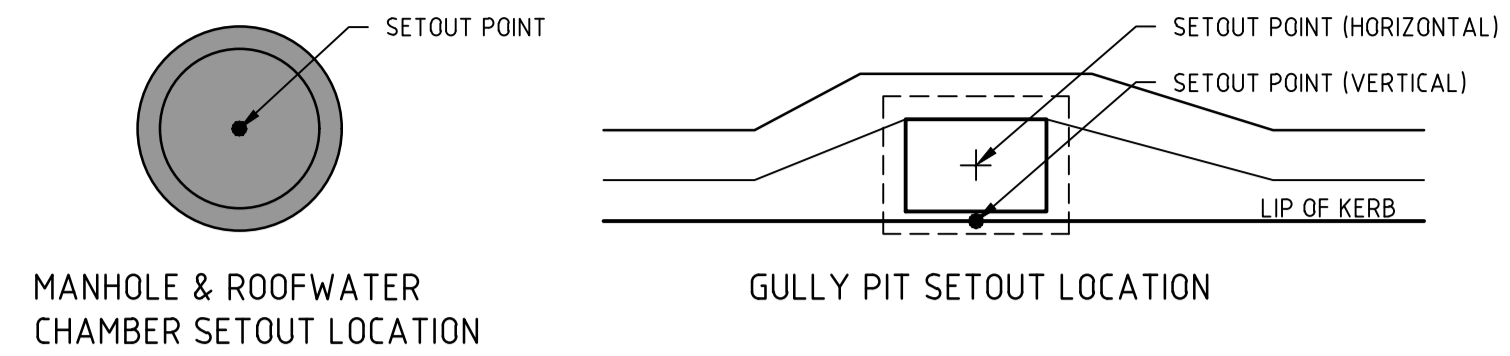

SETOUT POINTS LOCATION DETAIL
N.T.S

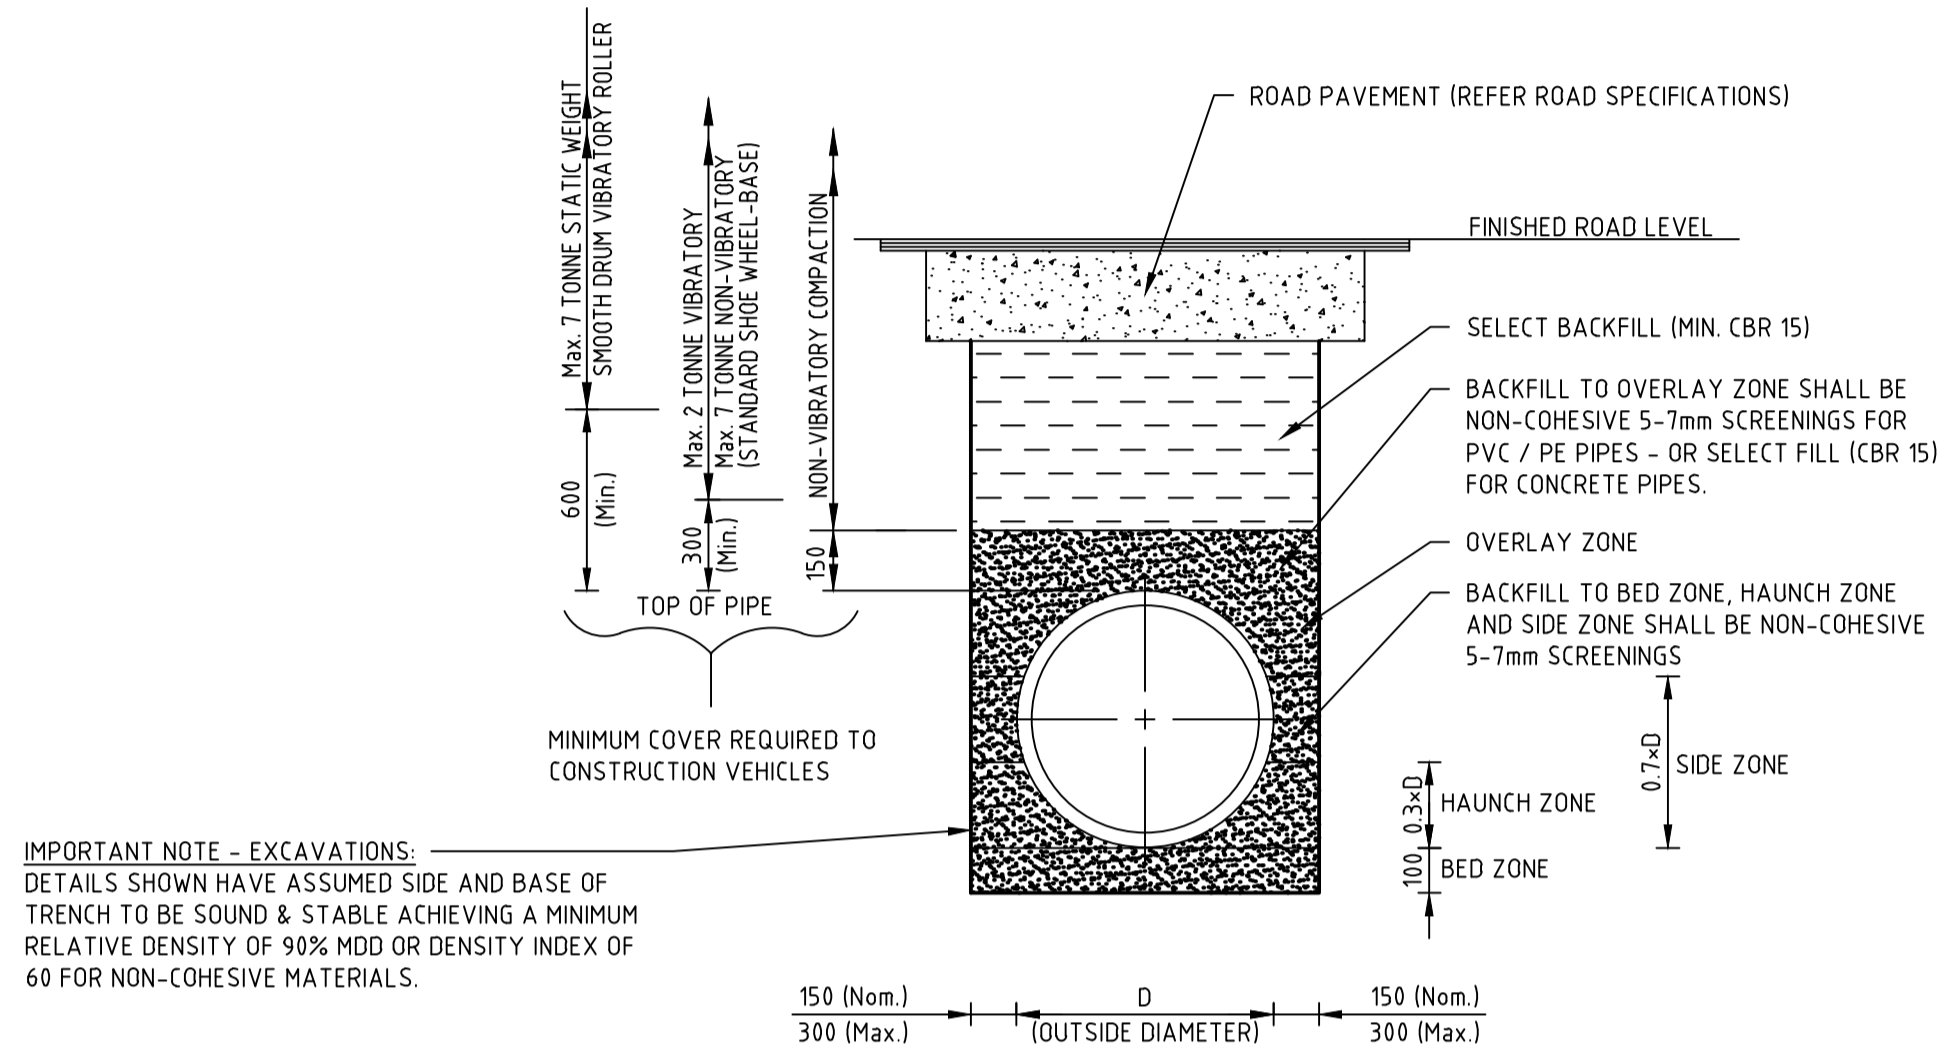

IMPORTANT NOTE - EXCAVATIONS:
DETAILS SHOWN HAVE ASSUMED SIDE AND BASE OF TRENCH TO BE SOUND & STABLE ACHIEVING A MINIMUM RELATIVE DENSITY OF 90% MDD OR DENSITY INDEX OF 60 FOR NON-COHESIVE MATERIALS.

TYPICAL STORMWATER TRENCH DETAIL
TYPE "HS2" SUPPORT - SINGLE BARREL
N.T.S

WARNING
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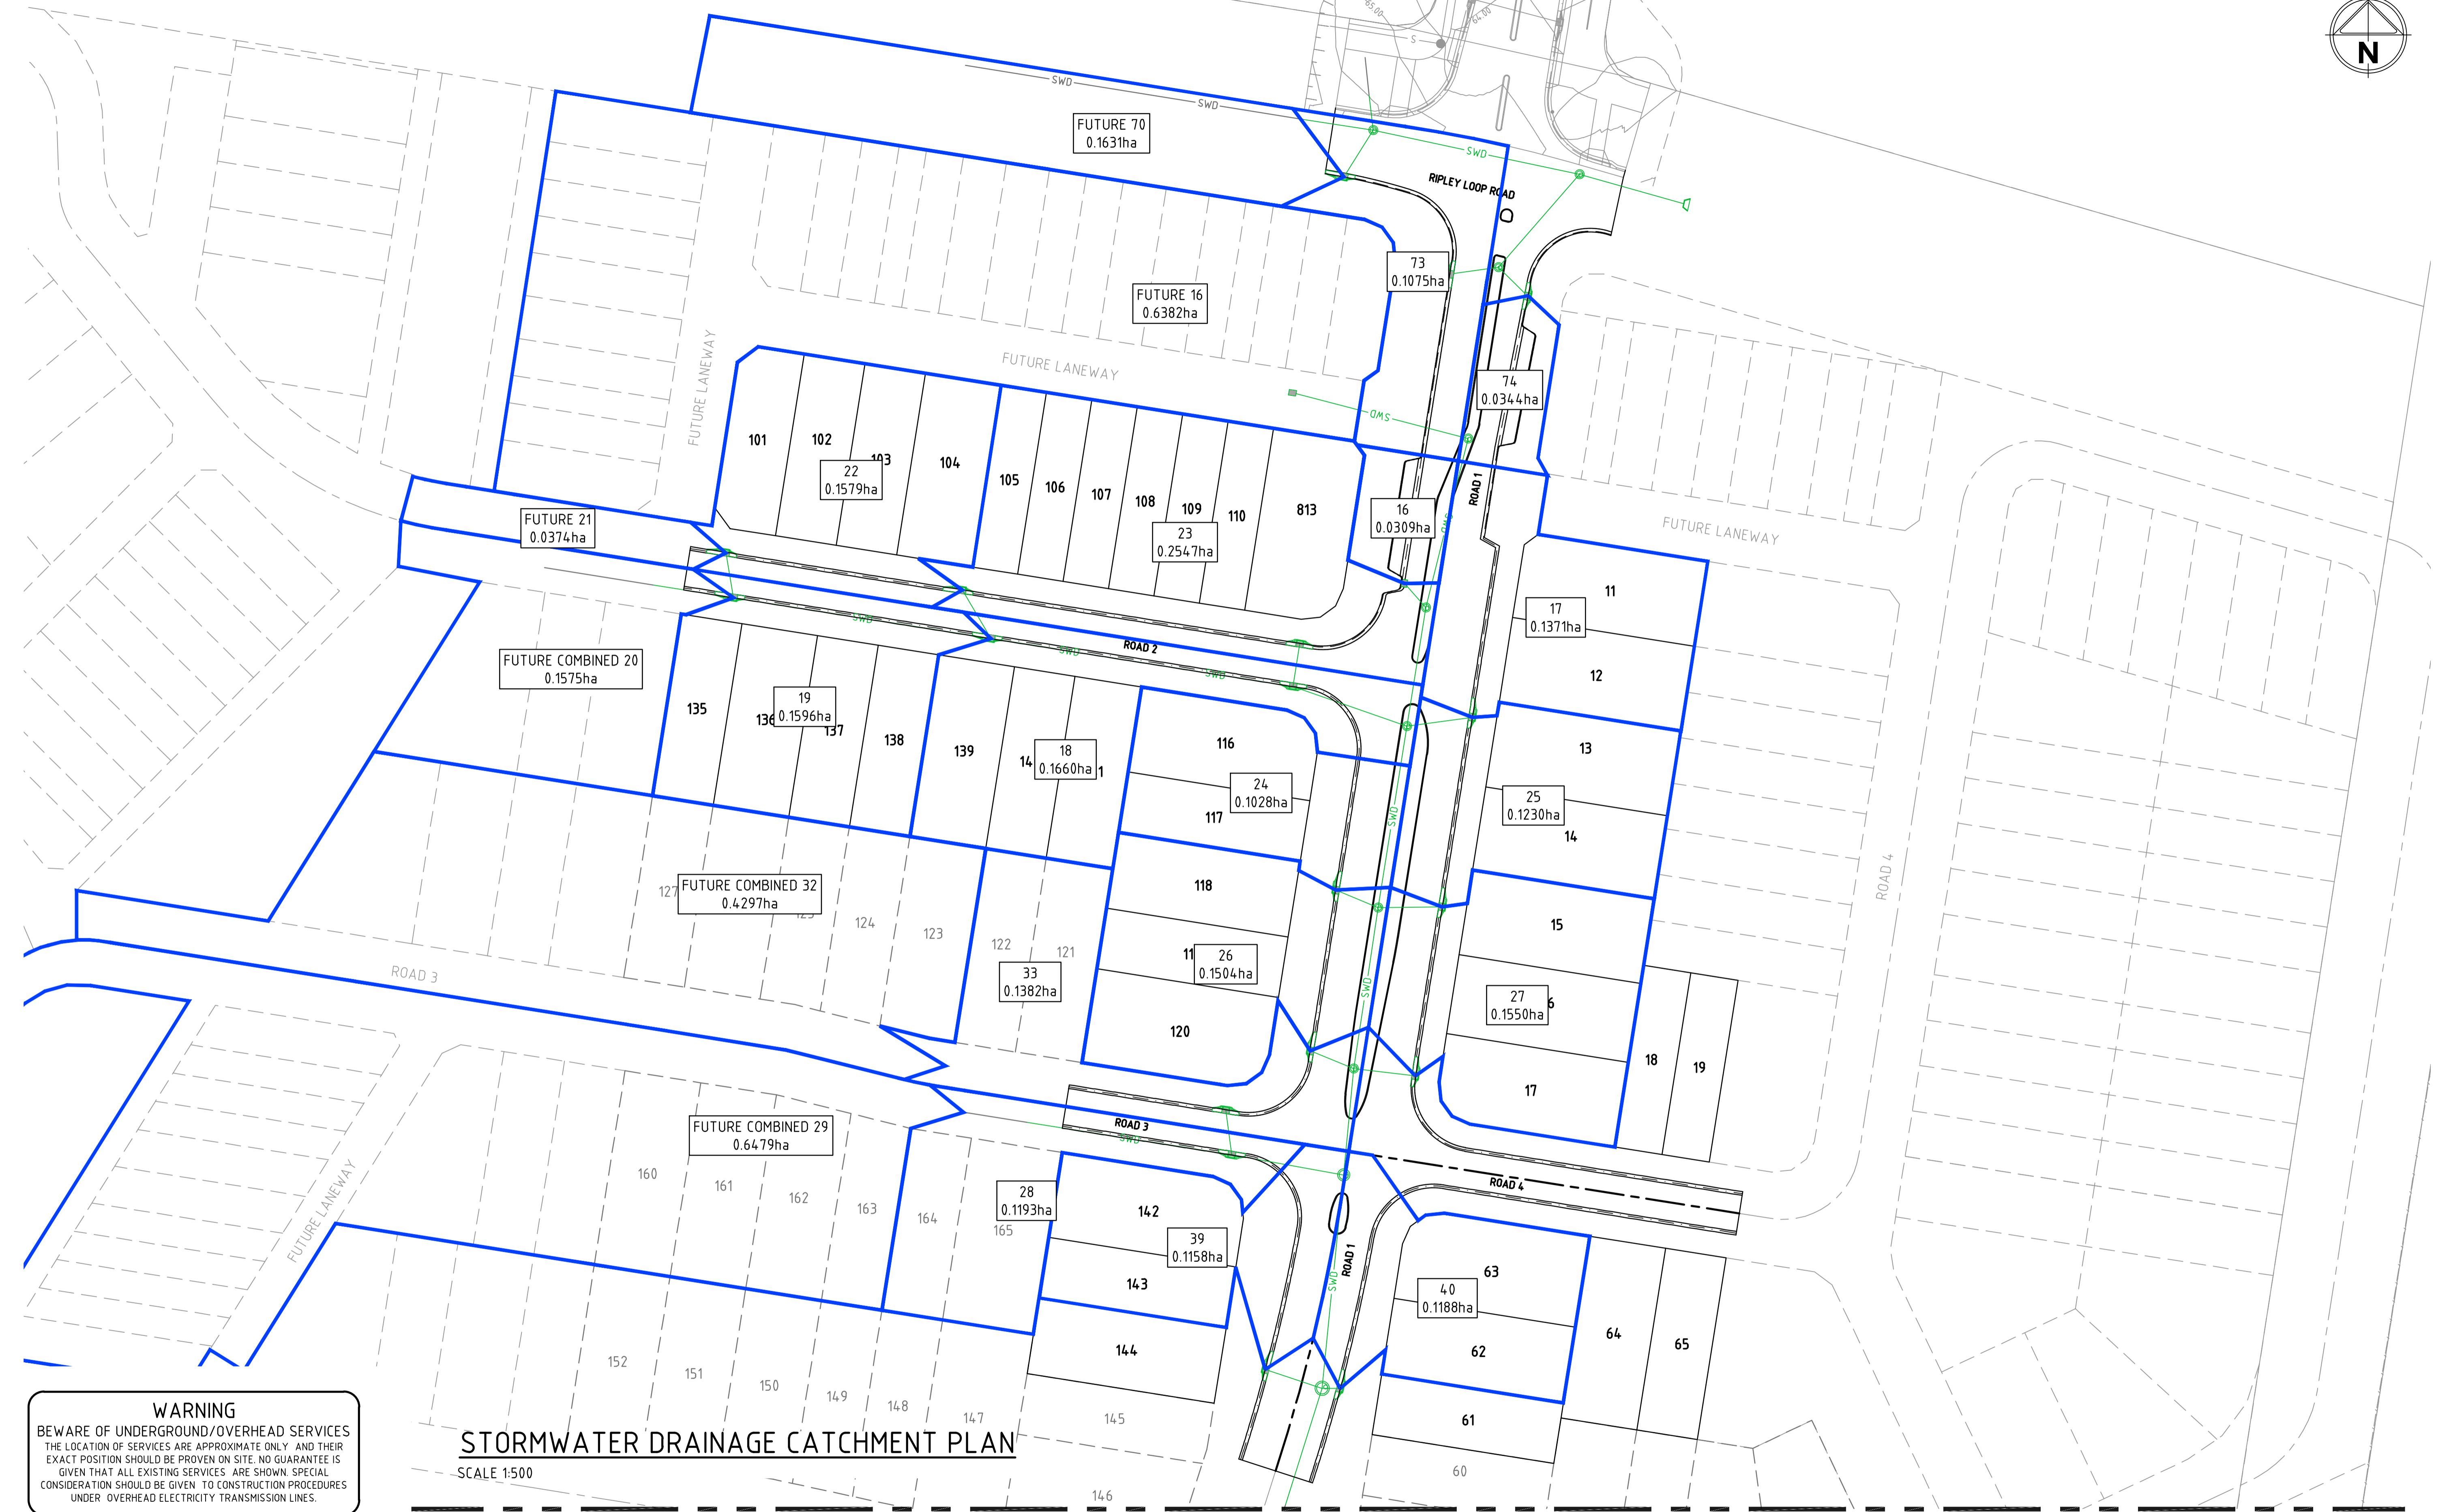
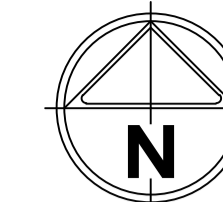
STAGE 01

STORMWATER DRAINAGE STANDARD NOTES & DETAILS

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PRELIMINARY Drg No: 320678-01C0500 Rev: B




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STORMWATER DRAINAGE CATCHMENT PLAN

SCALE 1:500

file name: 320678-01C0501.dwg; layout name: C0501; plotted by: Michael Bremer; file location: C:\Users\mbramer\OneDrive\Documents\320678-01C0501.dwg; plot date: 23/02/2024, 4:00 PM; Sheet: 6 of 7 Sheets

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STAGE 01
STORMWATER DRAINAGE CATCHMENT PLAN

IPSWICH CITY COUNCIL
 RIPLEY ROAD DEVELOPMENT PTY LTD

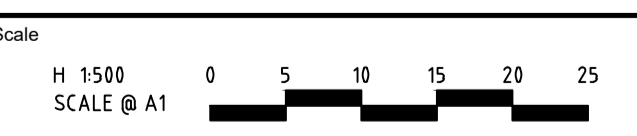PRELIMINARY Dwg No **320678-01C0501** Rev **B**

STORMWATER DRAINAGE LONGITUDINAL SECTIONS

SHEET 1 OF 4

SCALE HORIZONTAL 1:1000
VERTICAL 1:100

NOTES:

- ALL STORMWATER PIPELINES SHALL BE INSTALLED WITH TYPE "HS2" EMBEDMENT IN ACCORDANCE WITH AS 3725.
- ALL STORMWATER STRUCTURE COVERS SHALL BE CLASS 'D' TRAFFICABLE U.O.D.
- PIPE CLASS NOMINATED ON LONGITUDINAL SECTIONS ARE AS FOLLOWS:
 - U = uPVC CLASS "SN8"
 - 2 = RCP CLASS '2'
 - 3 = RCP CLASS '3'
 - 4 = RCP CLASS '4'

STRUCTURE NAME	STRUCTURE DESCRIPTION	PIPE SIZE (mm)	PIPE CLASS	PIPE GRADE (%)	PIPE SLOPE (1 in X)	FULL PIPE VELOCITY (m/s)	PART FULL VELOCITY (m/s)	DATUM RL	H.G.L IN PIPE & W.S.E IN STRUCTURE	PIPE FLOW (Cumecs)	PIPE CAPACITY AT GRADE (Cumecs)	DEPTH TO INVERT	INVERT LEVEL OF DRAINAGE	DESIGN SURFACE LEVEL	SETOUT COORDINATES	CHAINAGE
14	1050mm DIA. ACCESS CHAMBER REFER ICC STD. DRG. SD-02	525	RCP (CLASS 2)	0.50%	200.00	1.09	1.55	48.0	63.951 63.788	0.236	0.304	1.700	63.438	65.139	0.000 N 37234.009	0.000
13	1050mm DIA. ACCESS CHAMBER REFER ICC STD. DRG. SD-02	600	RCP (CLASS 2)	0.50%	200.00	0.87	1.58		63.705 63.674	0.246	0.434	1.821	63.296	65.023	28.408 N 37206.461	28.408
12	1200mm DIA. ACCESS CHAMBER REFER ICC STD. DRG. SD-02	750	RCP (CLASS 2)	0.50%	200.00	1.48	1.99		63.656 63.691	0.653	0.788	2.098	63.103	64.919	47.985 N 37187.126	29.949
11	1050mm DIA. ACCESS CHAMBER REFER ICC STD. DRG. SD-02	750	RCP (CLASS 2)	0.50%	200.00	1.66	2.02		63.415 63.347 63.370	0.733	0.788	2.103	62.672	64.775	77.934 N 37157.547	26.535
10	1200mm DIA. ACCESS CHAMBER REFER ICC STD. DRG. SD-02	900	RCP (CLASS 2)	2.00%	50.00	1.32	3.61		63.223 63.050 63.062	0.841	2.561	1.934	62.519	64.453	104.469 N 37131.310	17.428
9	1500mm DIA. ACCESS CHAMBER REFER ICC STD. DRG. SD-02	900	RCP (CLASS 2)	2.50%	40.00	2.10	4.42		62.934 62.822 62.996	1.335	2.864	2.269	61.836	63.993	121.898 N 37113.963	35.009
8	1500mm DIA. ACCESS CHAMBER REFER ICC STD. DRG. SD-02	900	RCP (CLASS 2)	2.50%	40.00	2.21	4.48		62.500 61.949 62.015	1.407	2.864	1.917	60.940	62.858	156.907 N 37079.131	25.000
7	1800mm DIA. ACCESS CHAMBER REFER ICC STD. DRG. SD-02	900	RCP (CLASS 2)	2.50%	40.00	2.21	4.48		61.622 61.206 61.242	1.407	2.864	1.840	60.295	62.136	181.907 N 37065.274	61.023

CONSTRUCT TWO (2) PIPE LENGTHS FROM END OF ROAD CONSTRUCTION AND CAP PIPE FOR FUTURE CONNECTION

15	900x600 FIELD INLET TYPE '2'	450	RCP (CLASS 2)	2.00%	50.00	1.50	2.64	51.0	64.565 64.395	0.238	0.403	1.485	64.052	65.537	0.000 N 37274.1510	29.673
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16	LIP IN LINE - GRATED KERB INLET PIT TYPE 'S' UNTEL REFER ICC STD. DRG. SD-04	375	RCP (CLASS 2)	1.00%	100.00	0.12	0.93	51.0	63.707 63.700	0.013	0.175	1.393	63.525	64.918	0.000 N 37210.421	5.368
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17	LIP IN LINE - GRATED KERB INLET PIT TYPE 'S' UNTEL REFER ICC STD. DRG. SD-04	375	RCP (CLASS 2)	2.00%	50.00	0.50	1.80	50.0	63.778 63.656	0.055	0.248	1.454	63.400	64.854	0.000 N 37188.576	10.768
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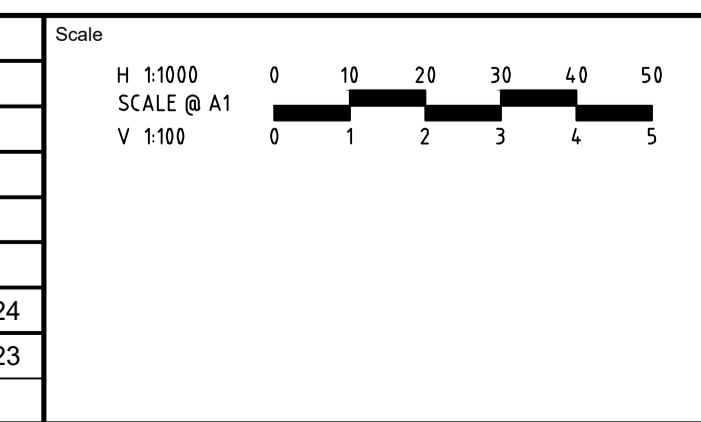
21	LIP IN LINE - GRATED KERB INLET PIT TYPE 'S' UNTEL REFER ICC STD. DRG. SD-04	375	RCP (CLASS 2)	1.00%	100.00	0.14	0.97	54.0	67.139 67.130	0.015	0.175	1.429	66.975	68.404	0.000 N 37215.377	7.455
20	LIP IN LINE - GRATED KERB INLET PIT TYPE 'S' UNTEL REFER ICC STD. DRG. SD-04	375	RCP (CLASS 2)	4.00%	25.00	0.71	2.56		67.131 67.146	0.078	0.351	1.432	66.900	68.332	7.455 E 9953.062	4.2514
19	LIP IN LINE - GRATED KERB INLET PIT TYPE 'S' UNTEL REFER ICC STD. DRG. SD-04	375	RCP (CLASS 2)	4.00%	25.00	1.74	3.25		67.085 65.608 65.657	0.192	0.351	1.452	66.880	66.504	4.9969 E 9895.051	49.870
18	LIP IN LINE - GRATED KERB INLET PIT (ISAGI) TYPE 'S' UNTEL REFER ICC STD. DRG. SD-04	525	RCP (CLASS 2)	0.50%	200.00	1.69	1.69		65.349 65.030	0.366	0.304	1.474	65.030	66.504	19.694 N 37201.422	119.534

22	LIP IN LINE - GRATED KERB INLET PIT TYPE 'S' UNTEL REFER ICC STD. DRG. SD-04	375	RCP (CLASS 2)	2.00%	50.00	0.53	1.83	54.0	65.756 65.678	0.058	0.248	1.518	65.238	66.757	0.000 N 37209.340	9.412
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23	LIP IN LINE - GRATED KERB INLET PIT (ISAGI) TYPE 'S' UNTEL REFER ICC STD. DRG. SD-04	450	RCP (CLASS 2)	0.50%	200.00	0.69	1.29	51.0	64.176 64.056	0.110	0.202	1.526	63.050	64.576	0.000 N 37200.606	7.085
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file name: 320678-01C0502.dwg, layout: as per C6502, plotted by: Michael Bensch, file location: C:\Users\michael_bensch\AppData\Local\Temp\320678-01C0502\320678-01C0502.dwg, 4:00 PM, Sheet 7 of 7, Sheets

Rev	Amendments	Approved	Date
B	ISSUE FOR TENDER	K.H.	21-02-24
A	ISSUE FOR APPROVAL	K.H.	01-12-23



System Certified

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 Queensland 4000 Australia T 61 7 3522 3000
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Designed _____ Checked _____

 Authorised _____ Date _____

 DECEMBER 23

AMORY AT RIPLEY
STAGE 01
STORMWATER DRAINAGE LONGITUDINAL SECTIONS
SHEET 1 OF 4
 IPSWICH CITY COUNCIL
 RIPLEY ROAD DEVELOPMENT PTY LTD

PRELIMINARY

 Drg No **320678-01C0502**

 Rev **B**

STORMWATER DRAINAGE LONGITUDINAL SECTIONS

SHEET 2 OF 3

SCALE HORIZONTAL 1:1000
VERTICAL 1:100

NOTES:

- ALL STORMWATER PIPELINES SHALL BE INSTALLED WITH TYPE "HS2" EMBEDMENT IN ACCORDANCE WITH AS 3725.
- ALL STORMWATER STRUCTURE COVERS SHALL BE CLASS 'D' TRAFFICABLE U.N.O.
- PIPE CLASS NOMINATED ON LONGITUDINAL SECTIONS ARE AS FOLLOWS:
 - U = uPVC CLASS "SN8"
 - 2 = RCP CLASS '2'
 - 3 = RCP CLASS '3'
 - 4 = RCP CLASS '4'

STRUCTURE NAME	82
STRUCTURE DESCRIPTION	LIP IN LINE - GRATED KERB INLET PIT TYPE 'S' UNTEL REFER ICC STD. DRG. SD-04
STRUCTURE NAME	20
STRUCTURE DESCRIPTION	LIP IN LINE - GRATED KERB INLET PIT TYPE 'S' UNTEL REFER ICC STD. DRG. SD-04

CONSTRUCT TWO (2) PIPE GTHS FROM END OF ROAD STRUCTION AND CAP PIPE FOR FUTURE CONNECTION

PIPE SIZE (mm)	375
PIPE CLASS	RCP (CLASS 2)
PIPE GRADE (%)	3.94%
PIPE SLOPE (1 in X)	25.35
FULL PIPE VELOCITY (m/s)	0.25
PART FULL VELOCITY (m/s)	1.88
DATUM RL	58.0
H.G.L IN PIPE & W.S.E IN STRUCTURE	68.390 68.368 67.131 67.146 67.085
PIPE FLOW (Cumecs)	0.027
PIPE CAPACITY AT GRADE (Cumecs)	0.348
DEPTH TO INVERT	1.426 1.332 1.452
INVERT LEVEL OF DRAINAGE	68.250 67.000 66.880
DESIGN SURFACE LEVEL	69.676 64.775
SETOUT COORDINATES	E 9821.761 N 3713.048 E 9853.062 N 3720.083
CHAINAGE	0.000 31.693 31.693

LINE FUTURE 1

STRUCTURE NAME	24
STRUCTURE DESCRIPTION	LIP IN LINE - GRATED KERB INLET PIT TYPE 'S' UNTEL REFER ICC STD. DRG. SD-04
STRUCTURE NAME	11
STRUCTURE DESCRIPTION	1050mm DIA. ACCESS CHAMBER REFER ICC STD. DRG. SD-02

PIPE SIZE (mm)	375
PIPE CLASS	RCP (CLASS 2)
PIPE GRADE (%)	2.00%
PIPE SLOPE (1 in X)	50.00
FULL PIPE VELOCITY (m/s)	0.38
PART FULL VELOCITY (m/s)	1.87
DATUM RL	51.0
H.G.L IN PIPE & W.S.E IN STRUCTURE	63.446 63.373 63.347 63.370 63.223
PIPE FLOW (Cumecs)	0.042
PIPE CAPACITY AT GRADE (Cumecs)	0.248
DEPTH TO INVERT	1.472 1.700 2.123
INVERT LEVEL OF DRAINAGE	63.225 63.075 62.652
DESIGN SURFACE LEVEL	64.697 64.775
SETOUT COORDINATES	E 9951.273 N 37160.473 E 9958.202 N 37157.547
CHAINAGE	0.000 7.510 7.510

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STRUCTURE NAME	25
STRUCTURE DESCRIPTION	LIP IN LINE - GRATED KERB INLET PIT TYPE 'S' UNTEL REFER ICC STD. DRG. SD-04
STRUCTURE NAME	11
STRUCTURE DESCRIPTION	1050mm DIA. ACCESS CHAMBER REFER ICC STD. DRG. SD-02

PIPE SIZE (mm)	375
PIPE CLASS	RCP (CLASS 2)
PIPE GRADE (%)	2.00%
PIPE SLOPE (1 in X)	50.00
FULL PIPE VELOCITY (m/s)	0.45
PART FULL VELOCITY (m/s)	1.75
DATUM RL	51.0
H.G.L IN PIPE & W.S.E IN STRUCTURE	63.460 63.361 63.347 63.370 63.223
PIPE FLOW (Cumecs)	0.049
PIPE CAPACITY AT GRADE (Cumecs)	0.248
DEPTH TO INVERT	1.497 1.784 2.123
INVERT LEVEL OF DRAINAGE	63.200 62.991 62.652
DESIGN SURFACE LEVEL	64.697 64.775
SETOUT COORDINATES	E 9968.641 N 37157.659 E 9958.202 N 37157.547
CHAINAGE	0.000 10.446 10.446

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STRUCTURE NAME	26
STRUCTURE DESCRIPTION	LIP IN LINE - GRATED KERB INLET PIT TYPE 'S' UNTEL REFER ICC STD. DRG. SD-04
STRUCTURE NAME	10
STRUCTURE DESCRIPTION	1200mm DIA. ACCESS CHAMBER REFER ICC STD. DRG. SD-02

PIPE SIZE (mm)	375
PIPE CLASS	RCP (CLASS 2)
PIPE GRADE (%)	2.00%
PIPE SLOPE (1 in X)	50.00
FULL PIPE VELOCITY (m/s)	0.56
PART FULL VELOCITY (m/s)	1.86
DATUM RL	51.0
H.G.L IN PIPE & W.S.E IN STRUCTURE	63.285 63.130 63.041 63.062 62.934
PIPE FLOW (Cumecs)	0.062
PIPE CAPACITY AT GRADE (Cumecs)	0.248
DEPTH TO INVERT	1.450 1.657 2.269
INVERT LEVEL OF DRAINAGE	62.950 62.796 62.184
DESIGN SURFACE LEVEL	64.400 64.453
SETOUT COORDINATES	E 9947.114 N 37134.197 E 9954.229 N 37131.310
CHAINAGE	0.000 7.690 7.690

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STRUCTURE NAME	27
STRUCTURE DESCRIPTION	LIP IN LINE - GRATED KERB INLET PIT TYPE 'S' UNTEL REFER ICC STD. DRG. SD-04
STRUCTURE NAME	10
STRUCTURE DESCRIPTION	1200mm DIA. ACCESS CHAMBER REFER ICC STD. DRG. SD-02

PIPE SIZE (mm)	375
PIPE CLASS	RCP (CLASS 2)
PIPE GRADE (%)	2.00%
PIPE SLOPE (1 in X)	50.00
FULL PIPE VELOCITY (m/s)	0.57
PART FULL VELOCITY (m/s)	1.87
DATUM RL	51.0
H.G.L IN PIPE & W.S.E IN STRUCTURE	63.265 63.107 63.041 63.062 62.934
PIPE FLOW (Cumecs)	0.062
PIPE CAPACITY AT GRADE (Cumecs)	0.248
DEPTH TO INVERT	1.445 1.730 2.269
INVERT LEVEL OF DRAINAGE	62.925 62.723 62.184
DESIGN SURFACE LEVEL	64.370 64.453
SETOUT COORDINATES	E 9964.270 N 37130.106 E 9954.229 N 37131.310
CHAINAGE	0.000 10.113 10.113

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STRUCTURE NAME	29
STRUCTURE DESCRIPTION	LIP IN LINE - GRATED KERB INLET PIT TYPE 'S' UNTEL REFER ICC STD. DRG. SD-04
STRUCTURE NAME	28
STRUCTURE DESCRIPTION	LIP IN LINE - GRATED KERB INLET PIT (ISAG) TYPE 'S' UNTEL REFER ICC STD. DRG. SD-04
STRUCTURE NAME	9
STRUCTURE DESCRIPTION	1500mm DIA. ACCESS CHAMBER REFER ICC STD. DRG. SD-02

PIPE SIZE (mm)	450
PIPE CLASS	RCP (CLASS 2)
PIPE GRADE (%)	5.00%
PIPE SLOPE (1 in X)	20.00
FULL PIPE VELOCITY (m/s)	2.48
PART FULL VELOCITY (m/s)	4.22
DATUM RL	55.0
H.G.L IN PIPE & W.S.E IN STRUCTURE	65.086 65.135 64.673 63.028 63.040 62.962 62.922 62.998 62.500
PIPE FLOW (Cumecs)	0.395
PIPE CAPACITY AT GRADE (Cumecs)	0.638
DEPTH TO INVERT	1.332 1.667 1.715 1.735 2.157 2.177
INVERT LEVEL OF DRAINAGE	64.590 64.255 62.041 62.021 61.836 61.816
DESIGN SURFACE LEVEL	65.922 63.756
SETOUT COORDINATES	E 9890.582 N 37124.168 E 9934.314 N 37117.229
CHAINAGE	54.560 44.279 98.839 18.532

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STRUCTURE NAME	33
STRUCTURE DESCRIPTION	LIP IN LINE - GRATED KERB INLET PIT (ISAG) TYPE 'S' UNTEL REFER ICC STD. DRG. SD-04
STRUCTURE NAME	28
STRUCTURE DESCRIPTION	LIP IN LINE - GRATED KERB INLET PIT (ISAG) TYPE 'S' UNTEL REFER ICC STD. DRG. SD-04

PIPE SIZE (mm)	450
PIPE CLASS	RCP (CLASS 2)
PIPE GRADE (%)	1.00%
PIPE SLOPE (1 in X)	100.00
FULL PIPE VELOCITY (m/s)	0.45
PART FULL VELOCITY (m/s)	1.49
DATUM RL	52.0
H.G.L IN PIPE & W.S.E IN STRUCTURE	63.107 63.033 63.028 63.040 62.962
PIPE FLOW (Cumecs)	0.071
PIPE CAPACITY AT GRADE (Cumecs)	0.285
DEPTH TO INVERT	1.531 1.600 1.735
INVERT LEVEL OF DRAINAGE	62.230 62.156 62.021
DESIGN SURFACE LEVEL	63.762 63.756
SETOUT COORDINATES	E 9933.356 N 37124.556 E 9934.314 N 37117.229
CHAINAGE	0.000 7.428 7.428

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STRUCTURE NAME	39
STRUCTURE DESCRIPTION	LIP IN LINE - GRATED KERB INLET PIT TYPE 'S' UNTEL REFER ICC STD. DRG. SD-04
STRUCTURE NAME	8
STRUCTURE DESCRIPTION	1500mm DIA. ACCESS CHAMBER REFER ICC STD. DRG. SD-02

PIPE SIZE (mm)	450
PIPE CLASS	RCP (CLASS 2)
PIPE GRADE (%)	1.00%
PIPE SLOPE (1 in X)	100.00
FULL PIPE VELOCITY (m/s)	0.30
PART FULL VELOCITY (m/s)	1.33
DATUM RL	50.0
H.G.L IN PIPE & W.S.E IN STRUCTURE	61.996 61.952 61.949 62.015 61.622
PIPE FLOW (Cumecs)	0.048
PIPE CAPACITY AT GRADE (Cumecs)	0.285
DEPTH TO INVERT	1.522 1.555 1.937
INVERT LEVEL OF DRAINAGE	61.400 61.302 60.920
DESIGN SURFACE LEVEL	62.922 62.858
SETOUT COORDINATES	E 9939.780 N 37082.238 E 9949.037 N 37079.131
CHAINAGE	0.000 9.765 9.765

24

STRUCTURE NAME	40
STRUCTURE DESCRIPTION	LIP IN LINE - GRATED KERB INLET PIT TYPE 'S' UNTEL REFER ICC STD. DRG. SD-04
STRUCTURE NAME	8
STRUCTURE DESCRIPTION	1500mm DIA. ACCESS CHAMBER REFER ICC STD. DRG. SD-02

PIPE SIZE (mm)	450
PIPE CLASS	RCP (CLASS 2)
PIPE GRADE (%)	2.00%
PIPE SLOPE (1 in X)	50.00
FULL PIPE VELOCITY (m/s)	0.30
PART FULL VELOCITY (m/s)	1.70
DATUM RL	49.0
H.G.L IN PIPE & W.S.E IN STRUCTURE	61.994 61.950 61.949 62.015 61.622
PIPE FLOW (Cumecs)	0.048
PIPE CAPACITY AT GRADE (Cumecs)	0.403
DEPTH TO INVERT	1.526 1.517 1.937
INVERT LEVEL OF DRAINAGE	61.400 61.341 60.920
DESIGN SURFACE LEVEL	62.926 62.858
SETOUT COORDINATES	E 9951.994 N 37079.135 E 9949.037 N 37079.131
CHAINAGE	0.000 2.974 2.974

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file name: 320678-01C0503.dwg, layout name: C0503, plotted by: Michael Bensch, file location: C:\Users\michael.bensch\OneDrive\Documents\320678-01C0503.dwg, plot date: 23/02/2024, 4:00 PM, Sheet 2 of 9 Sheets

Scale	H 1:1000 SCALE @ A1 V 1:100
Scale	
System Certified	
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Designed	Checked
Authorised	Date DECEMBER 23

Rev	Amendments	Approved	Date
B	ISSUE FOR TENDER	K.H.	21-02-24
A	ISSUE FOR APPROVAL	K.H.	01-12-23

spiire
AT RIPLEY

AMORY
AT RIPLEY

AMORY
AT RIPLEY

AMORY AT RIPLEY
STAGE 01
STORMWATER DRAINAGE LONGITUDINAL SECTIONS
SHEET 2 OF 3
IPSWICH CITY COUNCIL
RIPLEY ROAD DEVELOPMENT PTY LTD

PRELIMINARY

AMORY AT RIPLEY
STAGE 01
STORMWATER DRAINAGE LONGITUDINAL SECTIONS
SHEET 2 OF 3
IPSWICH CITY COUNCIL
RIPLEY ROAD DEVELOPMENT PTY LTD

PRELIMINARY

AMORY AT RIPLEY
STAGE 01
STORMWATER DRAINAGE LONGITUDINAL SECTIONS
SHEET 2 OF 3
IPSWICH CITY COUNCIL
RIPLEY ROAD DEVELOPMENT PTY LTD

PRELIMINARY

STORMWATER DRAINAGE LONGITUDINAL SECTIONS

SHEET 3 OF 3

SCALE HORIZONTAL 1:1000
VERTICAL 1:100

NOTES:

- ALL STORMWATER PIPELINES SHALL BE INSTALLED WITH TYPE "HS2" EMBEDMENT IN ACCORDANCE WITH AS 3725.
- ALL STORMWATER STRUCTURE COVERS SHALL BE CLASS 'D' TRAFFICABLE U.N.O.
- PIPE CLASS NOMINATED ON LONGITUDINAL SECTIONS ARE AS FOLLOWS:
 - U = uPVC CLASS "SN8"
 - 2 = RCP CLASS '2'
 - 3 = RCP CLASS '3'
 - 4 = RCP CLASS '4'

STRUCTURE NAME	67	66	65	64
STRUCTURE DESCRIPTION	1050mm DIA. ACCESS CHAMBER REFER ICC STD. DRG. SD-02	1050mm DIA. ACCESS CHAMBER REFER ICC STD. DRG. SD-02	1050mm DIA. ACCESS CHAMBER REFER ICC STD. DRG. SD-02	1050mm DIA. ACCESS CHAMBER REFER ICC STD. DRG. SD-02
PIPE SIZE (mm)	375	375	375	
PIPE CLASS	RCP (CLASS 2)	RCP (CLASS 2)	RCP (CLASS 2)	
PIPE GRADE (%)	3.00%	2.50%	1.00%	
PIPE SLOPE (1 in X)	33.33	40.00	100.00	
FULL PIPE VELOCITY (m/s)	0.40	1.17	1.66	
PART FULL VELOCITY (m/s)	1.96	2.47	1.80	
DATUM RL	51.0			
H.G.L IN PIPE & W.S.E IN STRUCTURE	65.940 65.919	64.133 64.153 63.985	63.832 63.865 63.679	63.161 63.189 62.946
PIPE FLOW (Cumecs)	0.044	0.129	0.183	
PIPE CAPACITY AT GRADE (Cumecs)	0.304	0.277	0.175	
DEPTH TO INVERT	1.527 1.547	1.542 1.570	1.585 1.824	1.558 1.635
INVERT LEVEL OF DRAINAGE	65.787 65.767	63.748 63.720	62.859 62.620	62.447 62.070
DESIGN SURFACE LEVEL	67.314	65.290	64.444	63.705
SETOUT COORDINATES	E 9890.886 N 37294.878	E 9957.343 N 37284.246	E 9991.038 N 37277.101	E 10036.465 N 37263.984
CHAINAGE	9.617	67.303	76.920 34.444	111.364 47.283

LINE

43

STRUCTURE NAME	70	66
STRUCTURE DESCRIPTION	LIP IN LINE - GRATED KERB INLET PIT TYPE 'S' UNTEL REFER ICC STD. DRG. SD-04	1050mm DIA. ACCESS CHAMBER REFER ICC STD. DRG. SD-02
PIPE SIZE (mm)	375	375
PIPE CLASS	RCP	RCP (CLASS 2)
PIPE GRADE (%)	0.50%	
PIPE SLOPE (1 in X)	199.64	
FULL PIPE VELOCITY (m/s)	0.40	
PART FULL VELOCITY (m/s)	1.03	
DATUM RL	51.0	
H.G.L IN PIPE & W.S.E IN STRUCTURE	64.216 64.137	64.133 64.155 63.985
PIPE FLOW (Cumecs)	0.044	
PIPE CAPACITY AT GRADE (Cumecs)	0.124	
DEPTH TO INVERT	1.477	1.570
INVERT LEVEL OF DRAINAGE	63.800	63.755
DESIGN SURFACE LEVEL	65.277	65.290
SETOUT COORDINATES	E 9952.595 N 37276.687	E 9957.343 N 37284.246
CHAINAGE	0.000	8.962

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STRUCTURE NAME	71	66
STRUCTURE DESCRIPTION	LIP IN LINE - GRATED KERB INLET PIT TYPE 'S' UNTEL REFER ICC STD. DRG. SD-04	1050mm DIA. ACCESS CHAMBER REFER ICC STD. DRG. SD-02
PIPE SIZE (mm)	375	375
PIPE CLASS	RCP (CLASS 2)	RCP (CLASS 2)
PIPE GRADE (%)	0.50%	
PIPE SLOPE (1 in X)	199.99	
FULL PIPE VELOCITY (m/s)	0.40	
PART FULL VELOCITY (m/s)	1.03	
DATUM RL	51.0	
H.G.L IN PIPE & W.S.E IN STRUCTURE	64.218 64.139	64.133 64.155 63.985
PIPE FLOW (Cumecs)	0.044	
PIPE CAPACITY AT GRADE (Cumecs)	0.124	
DEPTH TO INVERT	1.460	1.550
INVERT LEVEL OF DRAINAGE	63.800	63.740
DESIGN SURFACE LEVEL	65.260	65.290
SETOUT COORDINATES	E 9956.058 N 37296.147	E 9957.343 N 37284.246
CHAINAGE	0.000	11.986

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STRUCTURE NAME	73	72	65
STRUCTURE DESCRIPTION	LIP IN LINE - GRATED KERB INLET PIT (SAG) TYPE 'S' UNTEL REFER ICC STD. DRG. SD-04	1050mm DIA. ACCESS CHAMBER REFER ICC STD. DRG. SD-02	1050mm DIA. ACCESS CHAMBER REFER ICC STD. DRG. SD-02
PIPE SIZE (mm)	375	375	375
PIPE CLASS	RCP (CLASS 2)	RCP (CLASS 2)	RCP (CLASS 2)
PIPE GRADE (%)	0.50%	0.50%	
PIPE SLOPE (1 in X)	200.06	200.00	
FULL PIPE VELOCITY (m/s)	0.40	0.52	
PART FULL VELOCITY (m/s)	1.02	1.10	
DATUM RL	50.0		
H.G.L IN PIPE & W.S.E IN STRUCTURE	63.913 63.882	63.877 63.878 63.854	63.832 63.865 63.679
PIPE FLOW (Cumecs)	0.044	0.058	
PIPE CAPACITY AT GRADE (Cumecs)	0.124	0.124	
DEPTH TO INVERT	1.527	1.509 1.529	1.804 1.824
INVERT LEVEL OF DRAINAGE	62.800	62.760 62.740	62.640 62.620
DESIGN SURFACE LEVEL	64.327	64.269	64.444
SETOUT COORDINATES	E 9969.914 N 37260.848	E 9977.832 N 37261.979	E 9991.038 N 37277.101
CHAINAGE	0.000	8.018 20.076	28.095

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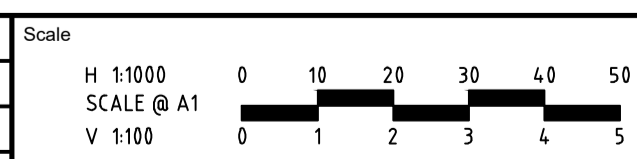
STRUCTURE NAME	74	72
STRUCTURE DESCRIPTION	LIP IN LINE - GRATED KERB INLET PIT TYPE 'S' UNTEL REFER ICC STD. DRG. SD-04	1050mm DIA. ACCESS CHAMBER REFER ICC STD. DRG. SD-02
PIPE SIZE (mm)	375	375
PIPE CLASS	RCP (CLASS 2)	RCP (CLASS 2)
PIPE GRADE (%)	0.50%	
PIPE SLOPE (1 in X)	199.99	
FULL PIPE VELOCITY (m/s)	0.13	
PART FULL VELOCITY (m/s)	0.74	
DATUM RL	50.0	
H.G.L IN PIPE & W.S.E IN STRUCTURE	63.881 63.877	63.877 63.878 63.854
PIPE FLOW (Cumecs)	0.014	
PIPE CAPACITY AT GRADE (Cumecs)	0.124	
DEPTH TO INVERT	1.516	1.453 1.529
INVERT LEVEL OF DRAINAGE	62.850	62.816 62.740
DESIGN SURFACE LEVEL	64.366	64.269
SETOUT COORDINATES	E 9982.662 N 37251.319	E 9977.832 N 37261.979
CHAINAGE	0.000	6.784

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CONSTRUCT TWO (2) PIPE LENGTHS FROM END OF ROAD CONSTRUCTION AND CAP PIPE FOR FUTURE CONNECTION

CONSTRUCT HEADWALL TO SUIT 375Ø PIPE. HEADWALL TO BE 18.0m FROM PIT 65

CONSTRUCT TWO (2) PIPE LENGTHS FROM END OF ROAD CONSTRUCTION AND CAP PIPE FOR FUTURE CONNECTION



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Authorised _____ Date _____
DECEMBER 23

AMORY AT RIPLEY
STAGE 01
STORMWATER DRAINAGE LONGITUDINAL SECTIONS
SHEET 3 OF 3
IPSWICH CITY COUNCIL
RIPLEY ROAD DEVELOPMENT PTY LTD

PRELIMINARY Drg No **320678-01C0504** Rev **B**

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